

Monclova Township

4335 Albon Road, Monclova, Ohio 43542

TEL 419-865-7862 FAX 419-865-8481 www.monclovatwp.org

Legal Notice

Monclova Twp
Monday, January 12, 2026, 5:30 PM
Meeting Room, 4335 Albon Road

Monclova Twp Board of Zoning Appeals has scheduled a public hearing to consider adding area to existing Conditional Use (Section 4.2 of the Zoning Resolution).

Site Location: 8605 Salisbury Rd; Road; Applicant: Redemption Church; Agent J. Cook, Mannik & Smith.

Text & map of this request is on file in the Zoning Office, 4335 Albon Rd.; Mon 12-4; Tues-Fri 8-4; call 419-865-7857; or visit monclovatwp.org under "Legal Notices" for file information.

By order of the Monclova Twp Board of Zoning Appeals

MONCLOVA TOWNSHIP

INTER-OFFICE


MEMO

To: Board of Zoning Appeals
Cc: Kathleen Kuns
From: Eric Wagner
Date: 12/22/25
Re: Request for a conditional use at 8605 Salisbury Rd.

Redemption Church recently purchased land adjoining their church property. After purchasing the property they tore down the existing house. They have combined the resulting vacant lot with their existing property. They are planning on building a 75x76 foot fellowship hall with a total square footage of 5570 square feet. They have provided a site plan as well as renderings and a floor plan for the building.

BENCHMARKS

SEE BENCHMARKS ON THE
 1/4" = 1' SCALE MAP OF THE
 TOWN OF MASON, OHIO, 1997
 CITY - 104.15 (104.15)
 SEE BENCHMARKS ON THE
 1/4" = 1' SCALE MAP OF THE
 TOWN OF MASON, OHIO, 1997
 CITY - 104.15 (104.15)

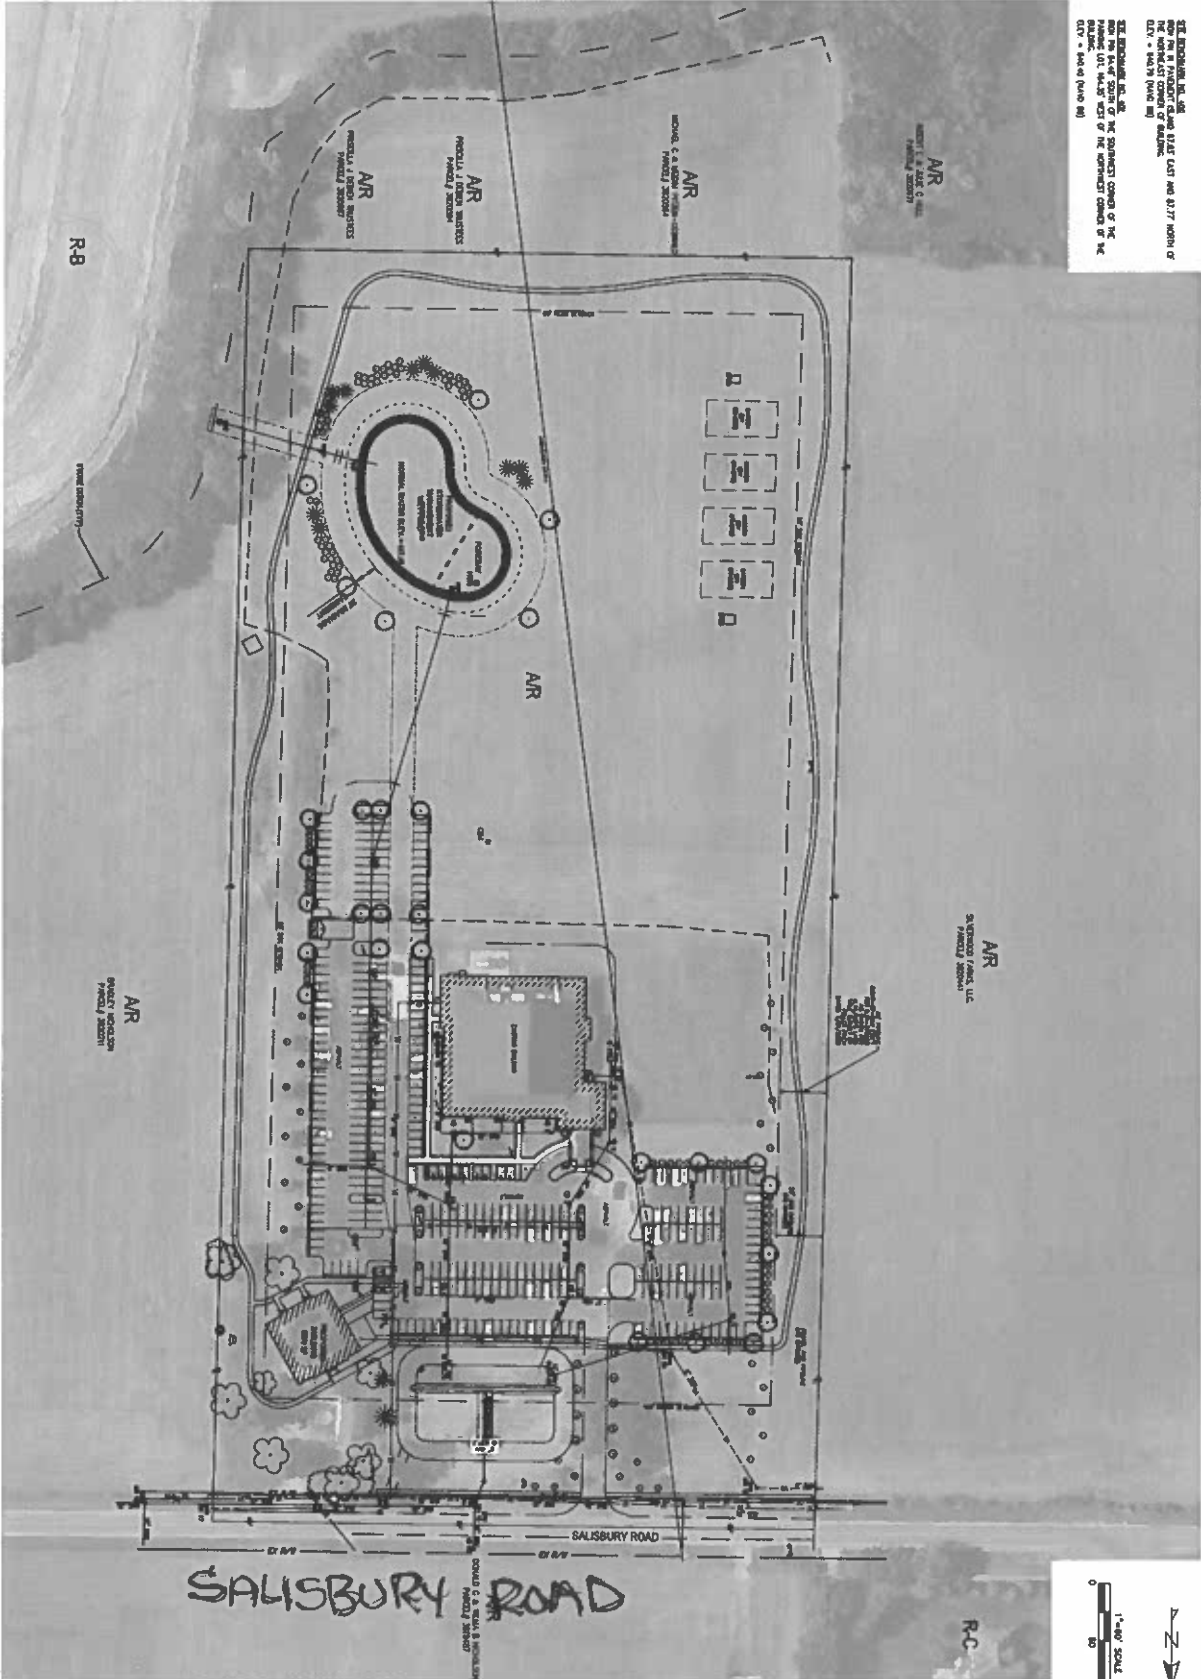

SALISBURY ROAD

R-C



C100

AERIAL PLAN

REDEMPTION CHURCH
 SPECIAL FUNCTION
 ACCESSORY BUILDING

6025 SALISBURY ROAD
 MASON, OHIO 45040

PREPARED FOR

REDEMPTION
 CHURCH

202 WEST MAIN STREET
 MASON, OHIO 45040



180 BROWN WOOD CIRCLE
 MASON, OHIO 45040
 TEL: 513.891.1000
 FAX: 513.891.1001

PROJECT DATE: MAY 1998
 PROJECT NO: 2000140
 DRAWN BY: JSM
 CHECKED BY: JSM

NO.	DATE	BY	DESCRIPTION
1	05/19/98	JSM	INITIAL DESIGN
2	06/01/98	JSM	REVISION 1
3	06/01/98	JSM	REVISION 2
4	06/01/98	JSM	REVISION 3
5	06/01/98	JSM	REVISION 4
6	06/01/98	JSM	REVISION 5
7	06/01/98	JSM	REVISION 6
8	06/01/98	JSM	REVISION 7
9	06/01/98	JSM	REVISION 8
10	06/01/98	JSM	REVISION 9
11	06/01/98	JSM	REVISION 10
12	06/01/98	JSM	REVISION 11
13	06/01/98	JSM	REVISION 12
14	06/01/98	JSM	REVISION 13
15	06/01/98	JSM	REVISION 14
16	06/01/98	JSM	REVISION 15
17	06/01/98	JSM	REVISION 16
18	06/01/98	JSM	REVISION 17
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97	06/01/98	JSM	REVISION 96
98	06/01/98	JSM	REVISION 97
99	06/01/98	JSM	REVISION 98
100	06/01/98	JSM	REVISION 99
101	06/01/98	JSM	REVISION 100



December 4, 2025

Eric Wagner
Monclova Township Zoning Administrator
4335 Albon Road
Monclova, Ohio 43542

**RE: Redemption Church
Special Function Accessory Building
Site Plan Review**

Dear Mr. Wagner:

On behalf of Redemption Church, please accept the attached submittal for Site Plan Review. Redemption Church has been experiencing tremendous growth and is finding the need to have a space to use for special functions. This project proposes a new 5570 sf accessory building at their existing facility at 8605 Salisbury Road. This building is intended to be used for special functions (Weddings, showers, etc.) and is not intended to be utilized at the same time as the main church building on Sunday mornings.

Construction is anticipated to begin as soon as plan approvals are in place. Redemption Church looks forward to working with Monclova Township through the approval process in the upcoming months.

Sincerely,

A handwritten signature in black ink, appearing to read 'Jeremy Cook'.

Jeremy Cook
Project Manager

Contact Info:

Jeremy Cook
The Mannik & Smith Group, Inc.
1800 Indian Wood Circle
Maumee, Ohio 43537
419-891-2222 Ext. 2105
jcook@manniksmithgroup.com

Steve Whitlow
Redemption Church
8605 Salisbury Rd
Monclova, Ohio 43542
419-494-6744
steven@experienceredemption.com

A PARCEL OF LAND SITUATED IN THE EAST 1/2 OF THE NORTHWEST 1/4 OF THE NORTHEAST QUARTER OF SECTION 31, TOWN 2, OF THE UNITED STATES RESERVE OF 12 MILES SQUARE, AT THE FOOT OF THE RAPIDS OF THE MIAMI OF LAKE ERIE IN MONCLOVA TOWNSHIP, IN THE COUNTY OF LUCAS AND STATE OF OHIO.

FURTHER DESCRIBE AS:

COMMENCING AT A ONE INCH IRON PIN IN A MONUMENT BOX AT THE NORTHEAST CORNER OF SECTION 31;

THENCE NORTH 89°06'06" WEST 1264.26 FEET TO A ONE INCH IRON PIN FOUND IN A MONUMENT BOX, ALSO BEING THE EAST 1/16 CORNER OF SECTION 31 BEING THE TRUE POINT OF BEGINNING;

THENCE SOUTH 01°25'12" WEST 1341.03 FEET ALONG THE NORTH/SOUTH 1/16 LINE OF SECTION 31 TO A POINT PASSING A CONCRETE MONUMENT FOUND AT 31.65 FEET, ALSO PASSING A CAPPED IRON PIN FOUND (LEWANDOWSKI) AT 49.63 FEET TO A POINT;

THENCE NORTH 89°04'53" WEST 637.08 FEET TO A POINT ON THE WEST LINE OF THE EAST 1/2 OF THE NORTHWEST 1/4 OF SECTION 31;

THENCE NORTH 01°38'00" EAST 1341.25 FEET ALONG THE SAID WEST LINE TO A POINT;

THENCE SOUTH 89°03'59" EAST 632.08 TO THE TRUE POINT OF BEGINNING.

CONTAINING 19.537 ACRES OF LAND MORE OR LESS.

PARCEL ID NUMBER 3820501

SUBJECT TO ALL EASEMENTS & RESTRICTIONS OF RECORD, IF ANY.

THE BEARINGS CONTAINED HEREIN ARE BASED ON THE BEARING OF NORTH 89°06'06" WEST FOR THE CENTERLINE OF SALISBURY ROAD AS REFERENCED TO THE OHIO STATE PLANE COORDINATE SYSTEM, NORTH ZONE, NAD83 (2011 ADJUSTMENT).

THIS DESCRIPTION WAS BASED ON AN ACTUAL FIELD SURVEY PERFORMED BY MANNIK AND SMITH GROUP INC. IN NOVEMBER OF 2025 UNDER THE DIRECT SUPERVISION OF JAMES E WILSON, P.S. 7744.


JAMES E WILSON, P.S.

LICENSED PROFESSIONAL SURVEYOR

NO. 7744



12-04-25

DATE



Fire Chief
Matthew P. Homik

MONCLOVA TOWNSHIP FIRE/RESCUE

Fire Prevention Bureau

4395 Albon Road Monclova, Ohio 43542
Office: 419-865-9423 Fax: 419-865-8481
www.monclovatwp.org

26 December 2025

Mr. Eric Wagner
Monclova Township Zoning Administrator
4335 Albon Road
Monclova, Ohio 43542

REF: Redemption Church Special Function Accessory Building, 8605 Salisbury Road, Monclova, Ohio

Mr. Wagner,

I have reviewed the documentation submitted for the BZA Conditional Use. After reviewing, the Fire Prevention Bureau has no objections to this site review.

Sincerely,

A handwritten signature in black ink that reads "Ryan O. Grant".

Ryan Grant, FSI, FPI, CFPE
Fire Prevention Officer
Monclova Township Fire Department

Cc: Matthew Homik, Fire Chief

REDEMPTION CHURCH SPECIAL FUNCTION ACCESSORY BUILDING

BENCHMARKS

SITE BENCHMARK NO. 400
IRON PIN IN PAVEMENT ISLAND 67.83' EAST AND 87.77' NORTH OF
THE NORTHEAST CORNER OF BUILDING.
ELEV. = 640.79 (NAVD 88)

SITE BENCHMARK NO. 401
IRON PIN 94.48' SOUTH OF THE SOUTHWEST CORNER OF THE
PARKING LOT, 164.35' WEST OF THE NORTHWEST CORNER OF THE
BUILDING.
ELEV. = 640.40 (NAVD 88)

INDEX OF SHEETS	
SHEET NO.	DESCRIPTION
C000	TITLE SHEET
C010	GENERAL NOTES
C100	AERIAL PLAN
C110	EXISTING CONDITIONS
C150	ENLARGED DEMOLITION PLAN
C200	OVERALL SITE PLAN
C210	ENLARGED SITE PLAN
C300	OVERALL GRADING PLAN
C310	ENLARGED GRADING PLAN
C400	OVERALL UTILITY PLAN
C410	ENLARGED UTILITY PLAN
C420	NORTH POND DRAINAGE MAPS
C430	NORTH POND DETENTION CALCS
C440	SOUTH POND DRAINAGE MAPS
C450	SOUTH POND DETENTION CALCS
C460	STORM PIPING DRAINAGE MAP
C470	SANITARY PLAN AND PROFILE
C480	STORM PROFILES
C500	DETAIL SHEET
C600	SWPPP PLAN
C610	SWPPP DETAILS
C620	SWPPP NOTES
L100	ENLARGED LANDSCAPE PLAN
L110	LANDSCAPE NOTES AND DETAILS



LEGEND

DESCRIPTION	EXISTING	PROPOSED
IRON PIN SET	● I.P.S.	
CARPENTERS NAIL FOUND	● NAIL	
IRON PIPE FOUND	⊙ P.F.	
MONUMENT BOX FOUND	Ⓜ	
IRON PIN FOUND	○ I.P.F.	
MAG NAIL SET	● M.N.S.	
STORM SEWER MANHOLE	⊗	● MH
CATCH BASIN	⊗ CB	■ CB
SANITARY SEWER MANHOLE	⊗	
WATER SERVICE MANHOLE	Ⓦ	
WATER GATE VALVE	Ⓦ	
FIRE HYDRANT	Ⓜ FH	
GUIDE POST		● GP
GAS METER	Ⓜ	
GAS LINE MARKER	+G	
GAS LINE VENT	ⓂG	
ELECTRIC METER	Ⓜ	
POWER POLE	Ⓜ	
ELECTRIC PEDESTAL	Ⓜ	
LIGHT POLE	Ⓜ	
GUY WIRE	Λ	
GUY WIRE ANCHOR	Λ	
TELEPHONE POLE	Ⓜ	
SIGNAL POLE	Ⓜ	
MONITOR WELL	Ⓜ	
SIGN	Ⓜ	
MAILBOX	Ⓜ	
SOIL BORING	Ⓜ	
POST	Ⓜ	
DECIDUOUS TREE	Ⓜ	Ⓜ
BUILDING	Ⓜ	Ⓜ
GUARD RAIL	Ⓜ	Ⓜ
TREE LINE	Ⓜ	Ⓜ
WATER LINE	Ⓜ W	Ⓜ
GAS LINE	Ⓜ G	Ⓜ
STORM LINE	Ⓜ ST	Ⓜ ST
SANITARY LINE	Ⓜ SA	Ⓜ
FIBER OPTIC	Ⓜ	Ⓜ
PROPERTY LINE	Ⓜ	Ⓜ
RIGHT-OF-WAY	Ⓜ RW	Ⓜ
FENCE	Ⓜ x	Ⓜ
CONTOURS	Ⓜ 600	Ⓜ 600

1. A PERMIT IS REQUIRED FROM THE LUCAS COUNTY ENGINEER'S OFFICE FOR ANY WORK WITHIN THE PUBLIC RIGHT OF WAY ON SALISBURY ROAD
2. A MINIMUM OF FIVE (5) CALENDAR DAYS PRIOR TO COMMENCING CLEARING OR DEMOLITION WORK, THE LUCAS COUNTY ENGINEERS OFFICE SHALL BE CONTACTED AT (419) 213-2860 TO ENSURE PROPER SEDIMENT AND EROSION CONTROL PRACTICES ARE IN PLACE BEFORE WORK BEGINS.



BY: MARK J. MATHE, PE

DATE: 12/04/2025

UNDERGROUND UTILITIES

TWO WORKING DAYS
BEFORE YOU DIG

CALL 1-800-362-2764 (TOLL FREE)

OHIO UTILITIES PROTECTION SERVICE
NON-MEMBERS
MUST BE CALLED DIRECTLY

PRELIMINARY
.....
**NOT TO BE USED FOR
CONSTRUCTION**

THE 2023 CONSTRUCTION MATERIAL STANDARD SPECIFICATIONS OF THE STATE OF OHIO, DEPARTMENT OF TRANSPORTATION INCLUDING CHANGES AND SUPPLEMENTAL SPECIFICATIONS LISTED IN THE PROPOSAL, SHALL GOVERN THIS IMPROVEMENT.

THE MANNIK & SMITH GROUP
1800 INDIAN WOOD CIRCLE
MAUMEE, OH 43537
TEL: 419-891-2222

REDEMPTION CITY CHURCH
8605 SALISBURY RD.
MONCLOVA, OH 43542
TEL: 419-601-4147

PROJECT CONTACT PERSON:
STEVE WITLOW
STEVE@EXPERIENCEREDEMPTION.COM

TOWN 2
UNITED STATES RESERVE
PART OF THE EAST ½ OF THE NORTHWEST ¼
OF THE NORTHEAST ¼ OF SECTION 31
MONCLOVA TOWNSHIP, LUCAS COUNTY, OHIO

REDEMPTION CHURCH DATE

LUCAS COUNTY ENGINEER'S OFFICE DATE

LUCAS COUNTY SANITARY ENGINEER



MONCLOVA TOWNSHIP

MONCLOVA TOWNSHIP FIRE	DATE
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SITE BENCHMARK NO. 400
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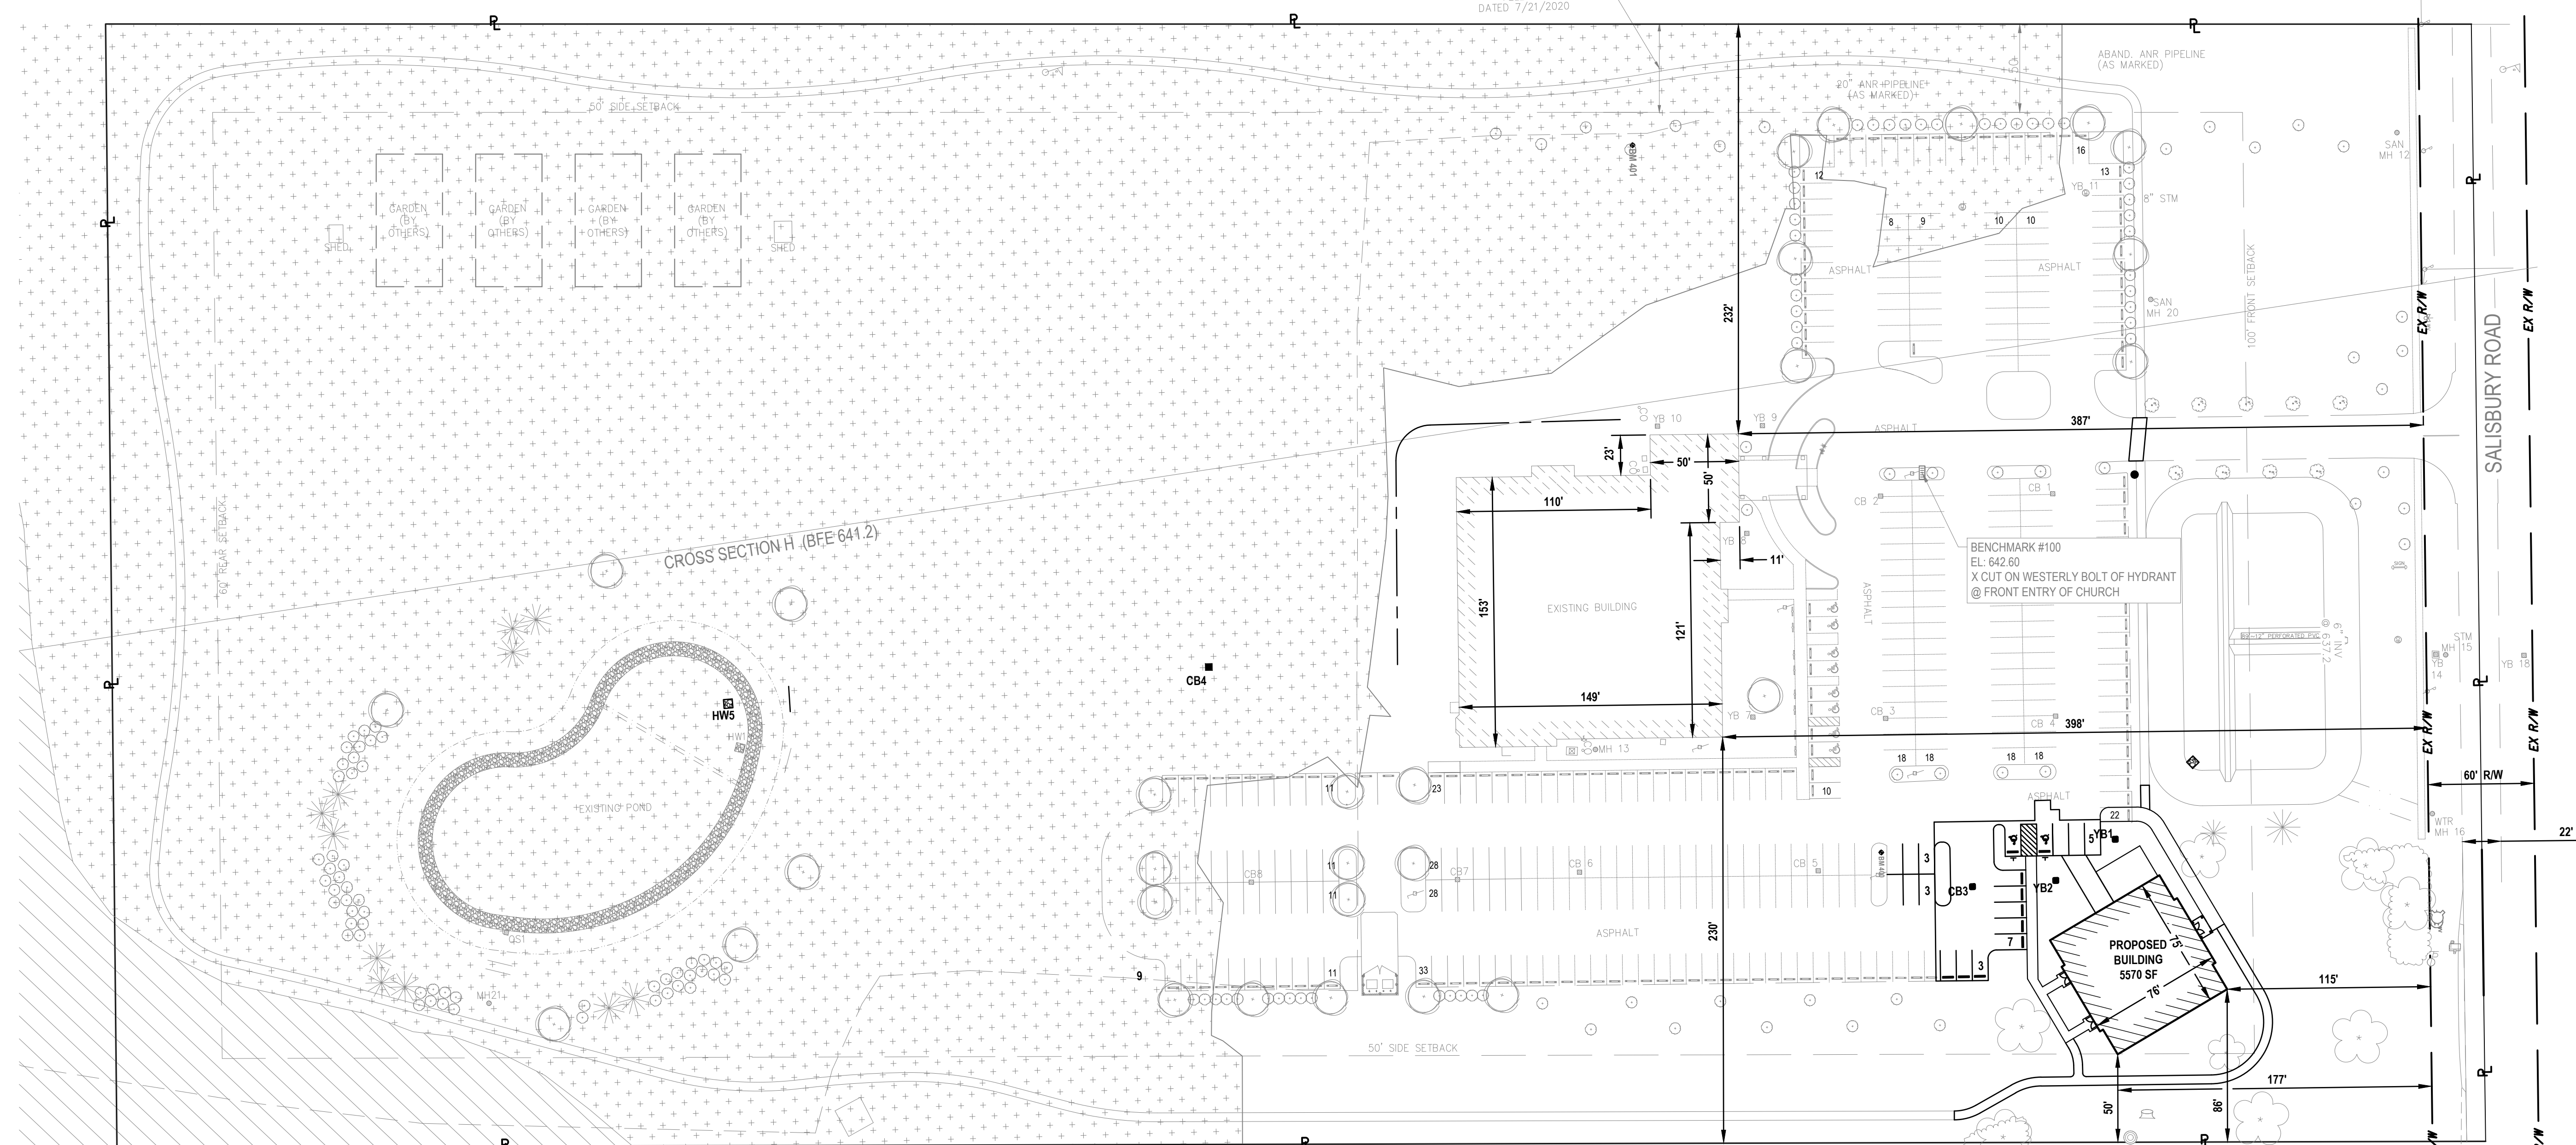
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LEGEND

- LIMITS OF SPECIAL FLOOD HAZARD
(BASED ON FLOOD ELEVATION)
- LIMITS OF REGULATORY FLOODWAY

EXISTING CONDITIONS	REDEMPTION CHURCH SPECIAL FUNCTION ACCESSORY BUILDING 8605 SALISBURY ROAD MONCLOVA, OH 43542	PREPARED FOR: REDEMPTION CHURCH 222 WEST MAIN STREET MASON, OH 45040	TECHNICAL SKILL: CREATIVE SPIRIT. www.MannikSmithGroup.com	NO. 1 DATE 10/30/2025 BY JEC JEC 12/24/2025	DESCRIPTION ISSUED FOR PERMITS JEC MONCLOVA TOWNSHIP SUBMITTAL
C110	8605 SALISBURY ROAD MONCLOVA, OH 43542	222 WEST MAIN STREET MASON, OH 45040	PROJECT DATE: 06/11/2025 PROJECT NO.: 250745 DRAWN BY: JEC CHECKED BY: MJM	1800 INDIAN WOOD CIRCLE MASON, OH 45040 TEL: 419.881.2222 FAX: 419.881.1595	10/30/2025 JEC 12/24/2025

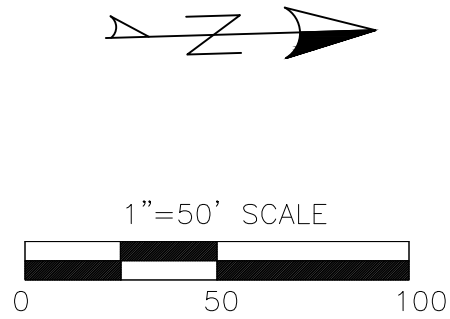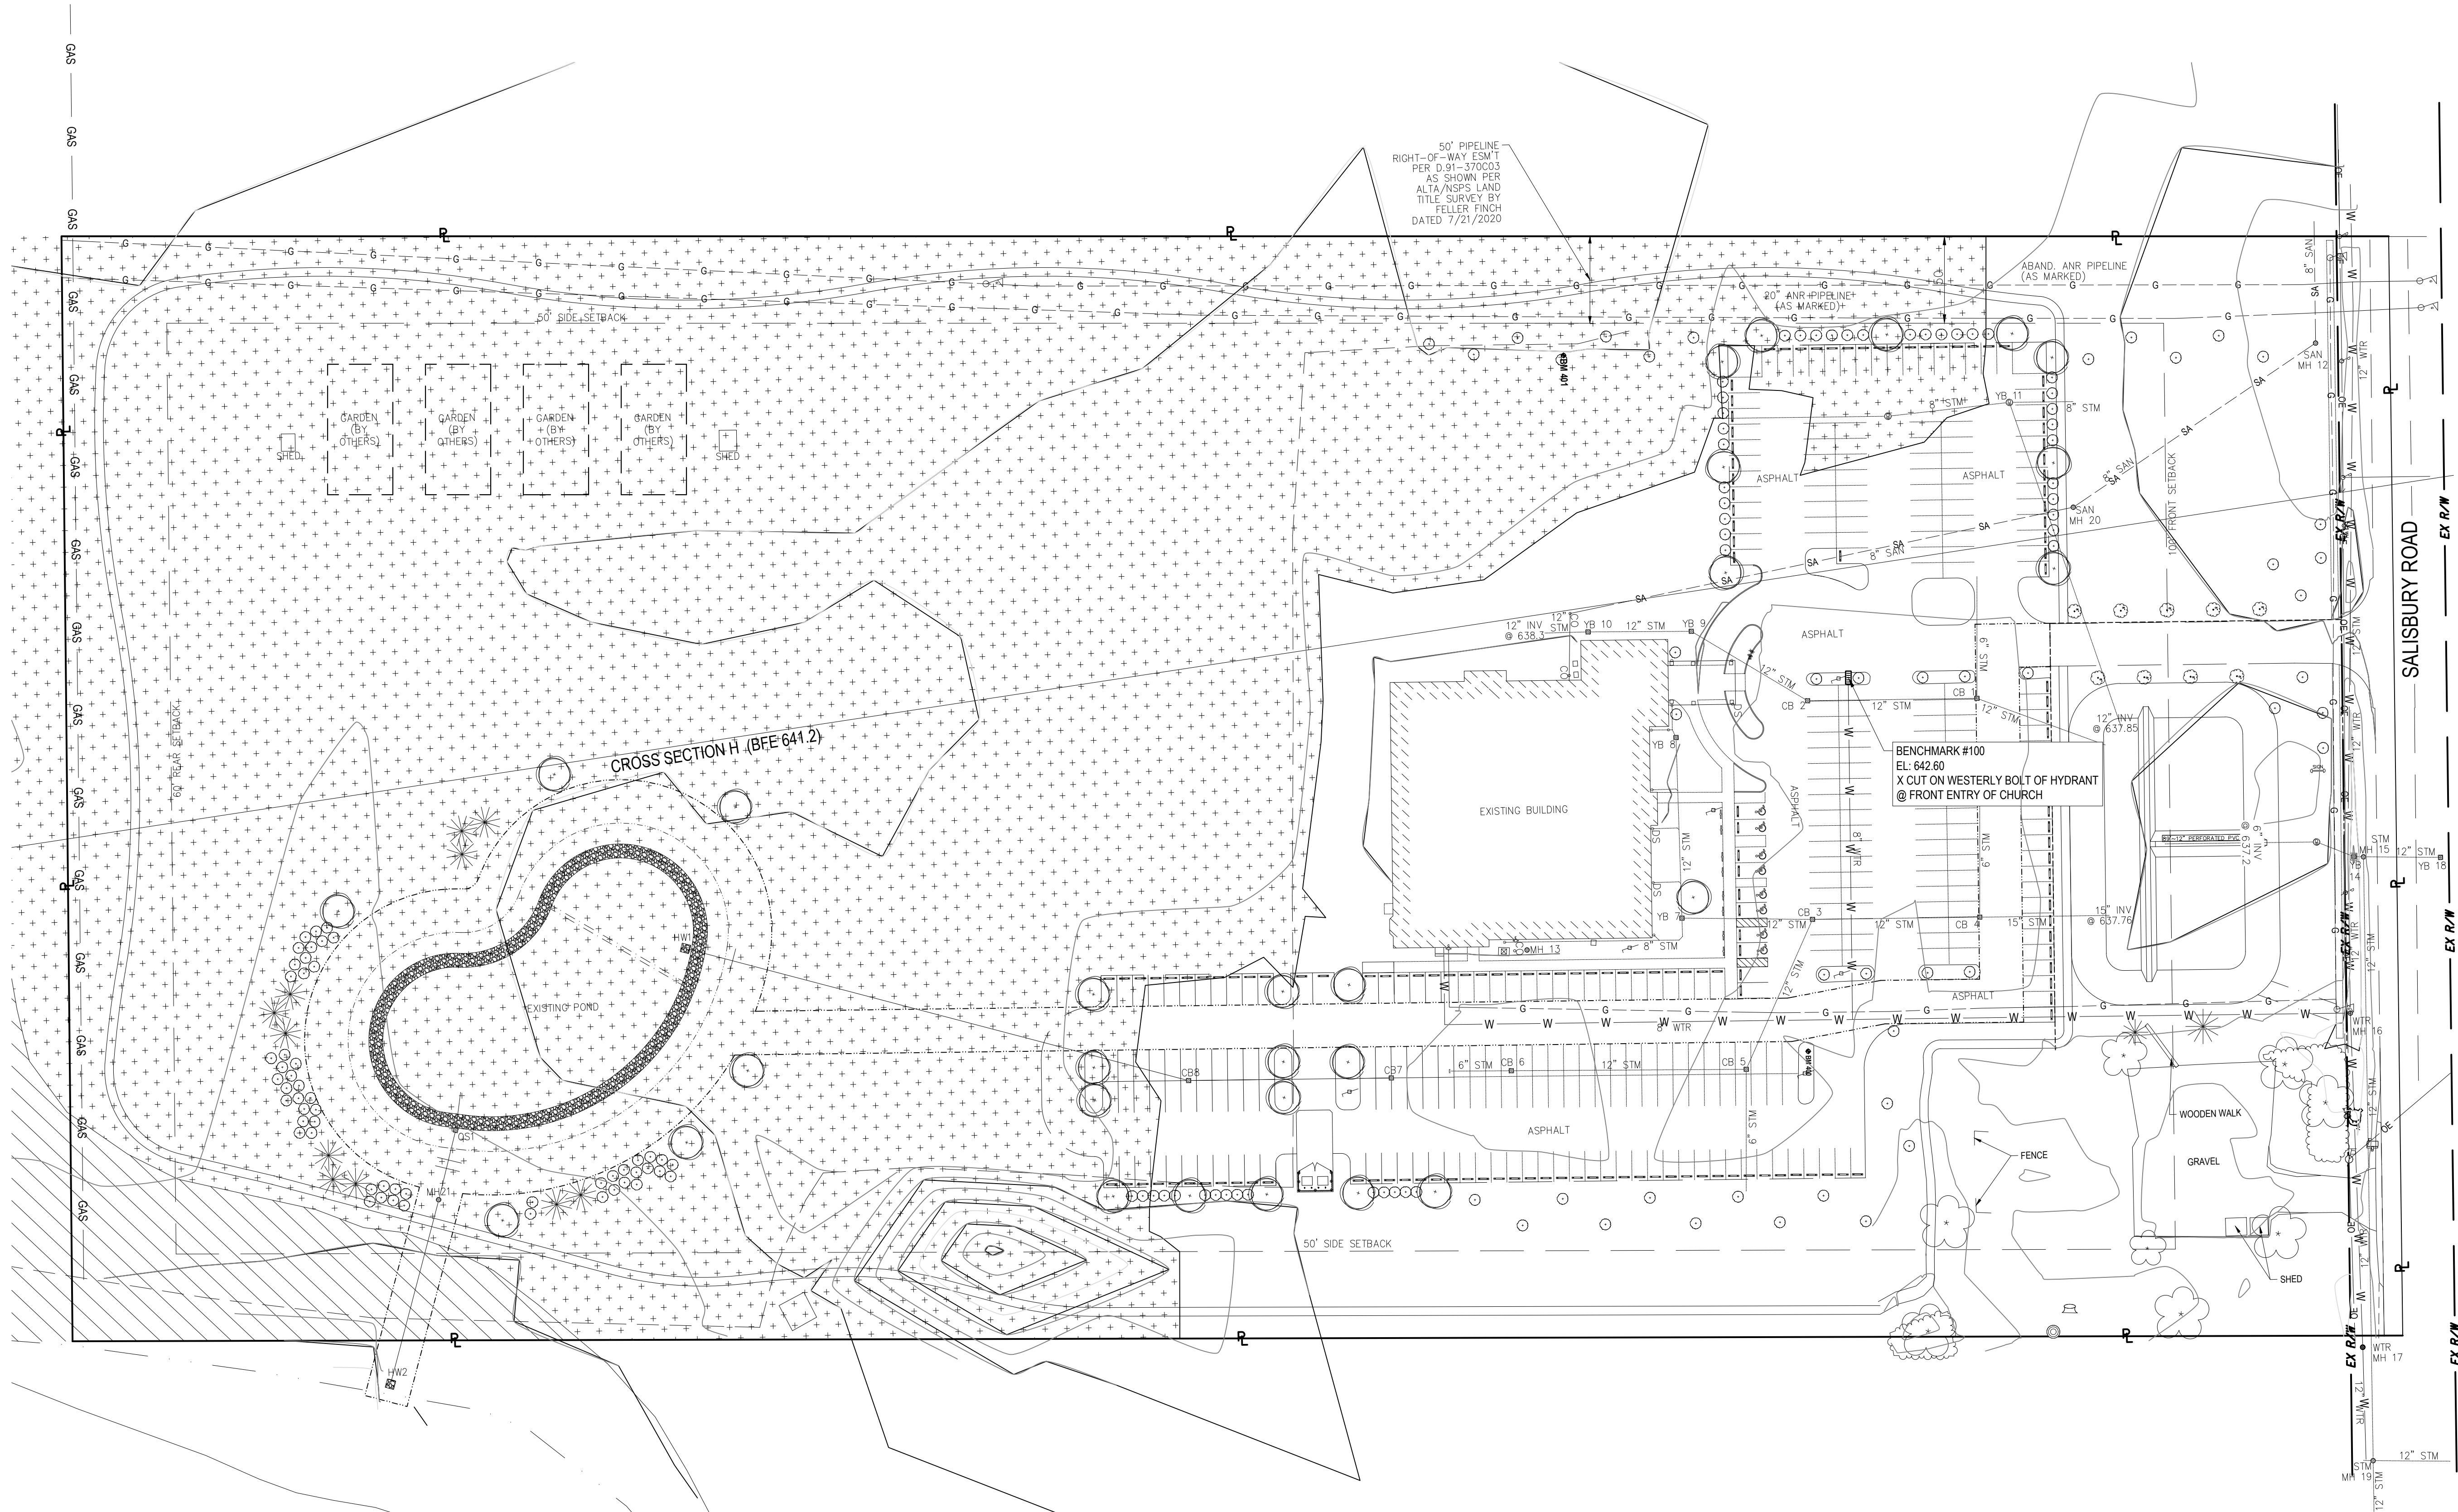

NOTES:

1. ACCESS ROAD TO BUILDING SHALL BE MAINTAINED THROUGHOUT CONSTRUCTION IN ACCORDANCE WITH OFC 503.1.1 AND 503.4

A diagram showing a rectangular arrangement of six plus signs (+) in a 2x3 grid.


LIMITS OF REGULATORY FLOODWAY

EXISTING PARKING	
ADA SPACES	= 8
STANDARD SPACES	= 33
TOTAL SPACES	= 33

PROPOSED PARKING

ADA SPACE	= 2
STANDARD SPACES	= 19
TOTAL PROPOSED SPACES	= 21

TOTAL PARKING ON SITE = 35

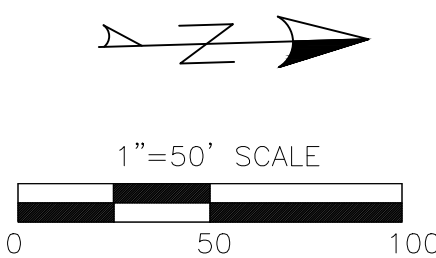

OVERALL SITE PLAN

REDEMPTION CHURCH
SPECIAL FUNCTION
ACCESSORY BUILDING

PREPARED FOR:
**REDEMPTION
CHURCH**
002 WEST MAIN STREET






**Mannik
Smith
GROUP**


TECHNICAL SKILL.
CREATIVE SPIRIT.


www.MannikSmithGroup.com

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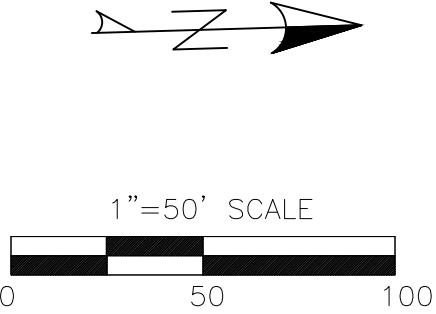
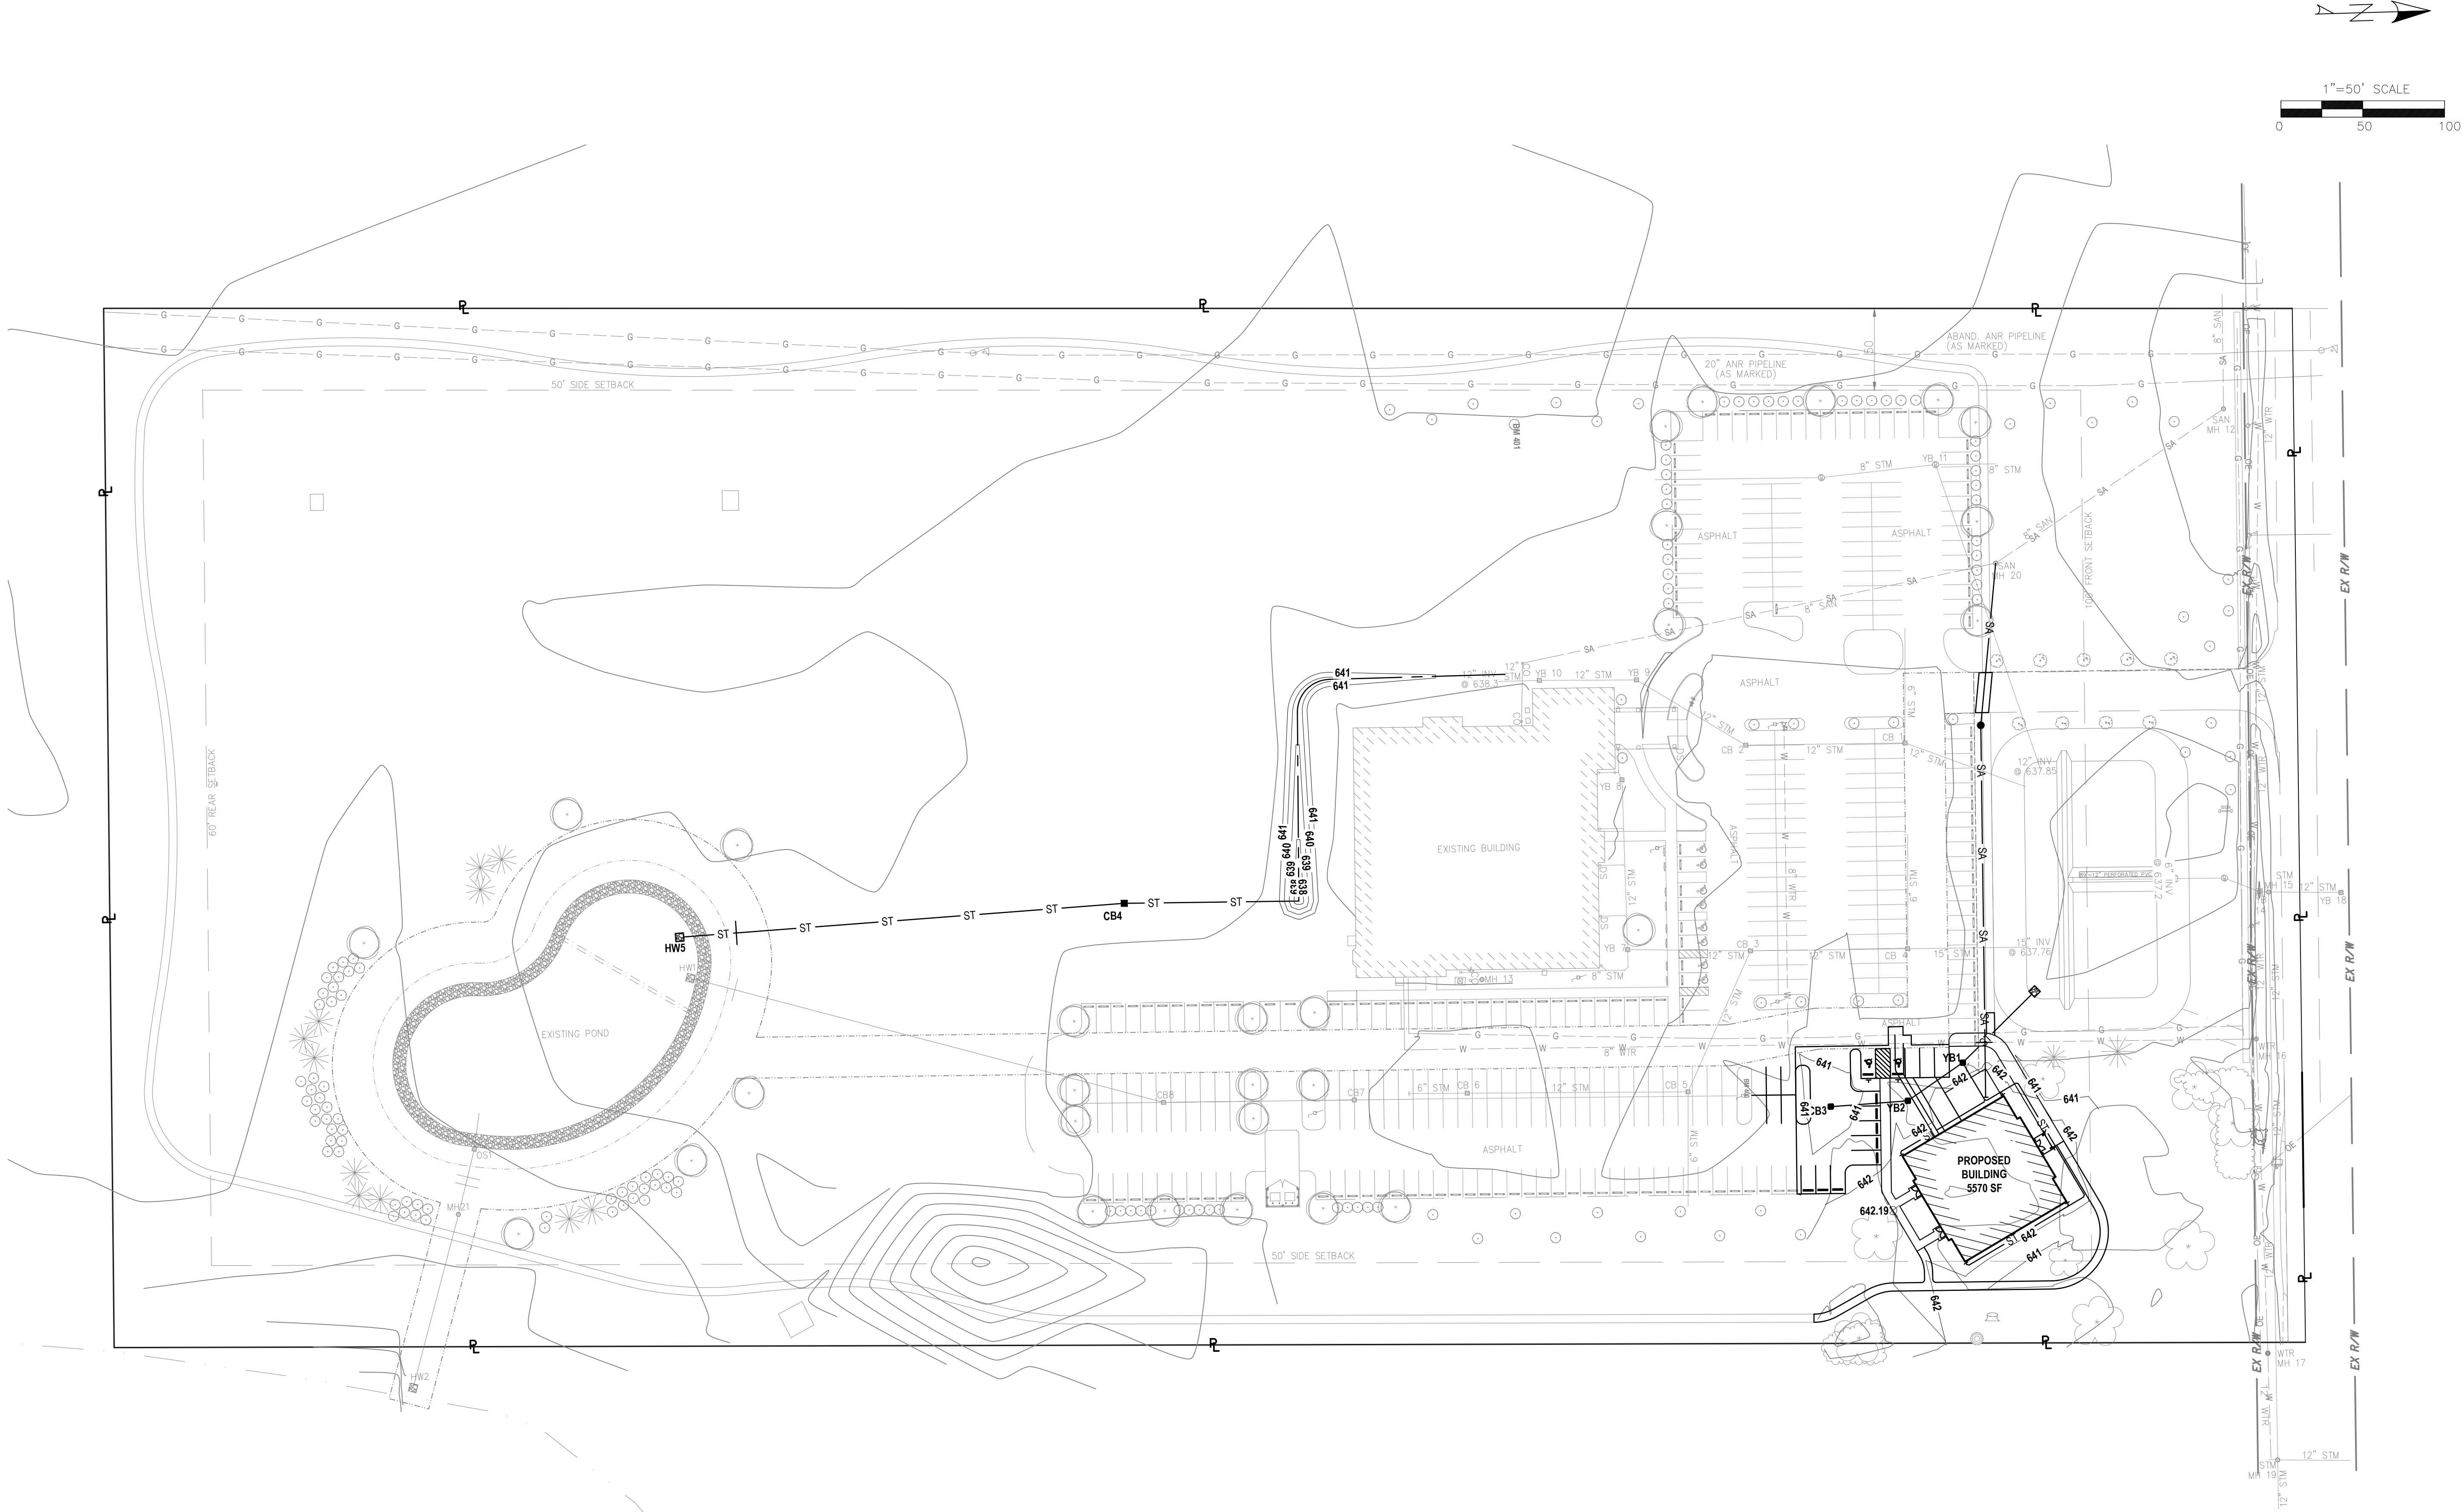
LEGEND

- | | |
|---|---|
|  | PROPOSED LIGHT DUTY PAVEMENT
SEE DETAIL, SHEET C500 |
|  | PROPOSED CONCRETE SIDEWALK
SEE DETAIL, SHEET C500 |
|  | PROPOSED GRAVEL DRIVE
SEE DETAIL, SHEET C500 |

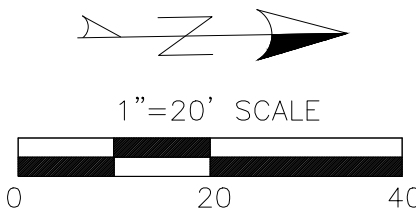

C210	ENLARGED SITE PLAN	REDEMPTION CHURCH SPECIAL FUNCTION ACCESSORY BUILDING 8605 SAUSBURY ROAD MONCLOVA, OH 43942	PREPARED FOR: REDEMPTION CHURCH 202 WEST MAIN STREET MASON, OH 45440	 Mannik Smith GROUP www.MannikSmithGroup.com	TECHNICAL SKILL - CREATIVE SPIRIT.	PROJECT NO.: 2500745 DRAWN BY: JEC CHECKED BY: NUM	PROJECT DATE: 06/11/2025	1800 INDIAN WOOD CIRCLE MAUMEE, OH 43537 PHONE: 419-881.1882 FAX: 419-881.1895	NO. 1 2	DATE 10/30/2025 12/04/2025	BY JEC JEC	DESCRIPTION ISSUED FOR PERMITS MONCLOVA TOWNSHIP SUBMITTAL
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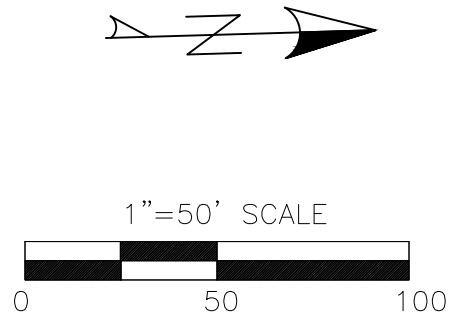
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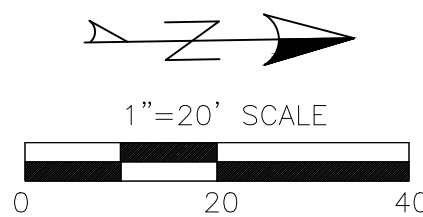
- NOTE:
1. THE APPROVED SITE GRADING AND DRAINAGE MAY NOT BE CHANGED WITHOUT THE AUTHORIZATION OF THE LUCAS COUNTY ENGINEERS OFFICE.
 2. A SITE GRADING AND DRAINAGE INSPECTION PERMIT SHALL BE OBTAINED BY THE DEVELOPER, OR HIS REPRESENTATIVE, A MINIMUM OF FIVE (5) WORKING DAYS PRIOR TO FINAL GRADING AND SIDEWALK CONSTRUCTION WORK. APPLICATIONS FOR SAID PERMIT MAY BE OBTAINED AT THE OFFICE OF THE LUCAS COUNTY ENGINEER.
 3. IF CONSTRUCTION FOR THE PHASE 2 BUILDING EXPANSION HAS BEGUN PRIOR TO FINALIZING THE ACCESSORY BUILDING, REGRADING OF THE EXISTING SWALE IS NOT NECESSARY. STORM PIPING SHOULD BE INSTALLED AS SHOWN ON THESE PLANS AND CAPPED FOR EXTENSION AS PART OF THE NEXT PHASE.


GRADING LEGEND	
■ CB	CATCH BASIN
XXX.XX	PROPOSED ELEVATION
XXX.XXME	MATCH EXISTING ELEVATION
1.0%	PROPOSED FLOW ARROW
RIM	RIM ELEVATION OF CASTING
100	PR CONTOUR
100	EX CONTOUR

NO.	DATE	BY	DESCRIPTION	PROJECT NO.	PROJECT DATE	DRAWN BY	CHECKED BY
1	10/30/2025	JEC	ISSUED FOR PERMITS	250745	06/11/2025	JEC	
2	12/04/2025	JEC	MONCLOVA TOWNSHIP SUBMITTAL				
				1800 INDIAN WOOD CIRCLE MASON, OH 45040 TEL: 419.881.2222 FAX: 419.881.1595			
				TECHNICAL SKILL: CREATIVE SPIRIT.			
				Mannik Smith Group www.MannikSmithGroup.com			
				PREPARED FOR: REDEMPTION CHURCH 202 WEST MAIN STREET MASON, OH 45040			
				REDEMPTION CHURCH SPECIAL FUNCTION ACCESSORY BUILDING 8605 SALISBURY ROAD MONCLOVA, OH 43042			
				OVERALL GRADING PLAN			
				C300			



1. IF CONSTRUCTION FOR THE PHASE 2 BUILDING EXPANSION HAS BEGUN PRIOR TO FINALIZING THE ACCESSORY BUILDING, REGRADING OF THE EXISTING SWALE IS NOT NECESSARY. STORM PIPING SHOULD BE INSTALLED AS SHOWN ON THESE PLANS AND CAPPED FOR EXTENSION AS PART OF THE NEXT PHASE.



C410	ENLARGED UTILITY PLAN	REDEMPTION CHURCH SPECIAL FUNCTION ACCESSORY BUILDING 8605 SAULSBURY ROAD MONCLOVA, OH 43042	PREPARED FOR: REDEMPTION CHURCH 202 WEST MAIN STREET MASON, OH 45040	<div>Mannik Smith GROUP www.MannikSmithGroup.com</div> <div>TECHNICAL SKILL - CREATIVE SPIRIT.</div>	1800 INDIAN WOOD CIRCLE MAUMEE OH 43537 TEL: 419.881.2222 FAX: 419.881.1695	NO.	DATE	BY	DESCRIPTION
						1	10/20/2025	JEC	ISSUED FOR PERMITS
						2	12/04/2025	JEC	MONCLOVA TOWNSHIP SUBMITTAL
					PROJECT DATE: 06/11/2025				
					PROJECT NO: 2500745				
					DRAWN BY: JEC				
					CHECKED BY: NJM				

UPDATED NORTH POND DETENTION CALCULATIONS PER PROPOSED IMPROVEMENTS

Lucas County Engineer's Office
STORMWATER DETENTION DESIGN

BY: Jeremy Cook **DATE:** 10-15-25

Notes:

Soil Type	Area	C		
A	137,478 sf	0.05	Length of Overland Flow (L)*	300 ft
B	93,861 sf	0.16	Slope of Overland Flow (S)	0.16%
C	28,072 sf	0.36	Length of Shallow Flow (L)*	309 ft
D	26,782 sf	0.47	Slope of Shallow Flow (S)	0.16%
Average C =	0.16		* switch to shallow flow after 300' +/- or where contours show a swale	

* use the lower C value for a mixed soil type, ie - for a type B-D use type B; Based on Open Space, Good Condition

$$\text{Overland Flow Calculation} = T_o = 1.8(1.2-C)L^{1/2}/S^{1/3}$$

$T_0 = 53.3$ minutes

$$\text{Shallow Concentrated Flow} = I_s = L / (60V)$$
$$v = 3.3 \text{ kS}^{1/2}$$

K=Forrest with heavy ground litter = 0.076 Min. tillage cultivated, woodland = 0.152

Short grass pasture = 0.213; Cultivated straight row = 0.274; Poor grass, untilled = 0.157; Poor grass, tilled = 0.131; Poor grass, no tillage = 0.220.

Grassed waterways = 0.457; Unpaved area, bare soil = 0.491; Paved area = 0.621

K(used) = 0.274 cultivated
V = 0.352 free

$v = 0.352 \text{ ips}$

Ts 14.2 minutes

$$T = T_o + T_s \quad 67.6 \text{ minutes}$$

Enter values pertinent to the site in all non-shaded outlined cells

TOTAL AREA (SQ. FT.):	286,193	6,570 Ac.		
ALLOWABLE AREA (SQ. FT.)	286,193	6,570 Ac.	SITE PERMIOUS C =	0.16
WET POND AREA (SQ. FT.)		c=1.00		
PAVEMENT AREA (SQ. FT.)	115,810	c=0.96	WT. C=Cw=	0.54
STONE AREA (SQ. FT.)		c=0.75		
BUILDING AREA (SQ. FT.)	19,642	c=0.96	ALLOW C =	0.16
FUTURE BLDG. AREA (SQ. FT.)		c=0.96	ALLOW Tc (mins.) =	67.57 20 mins Min.
TOTAL IMPERIOUS (SQ. FT.)	135,452		ALLOW I _s =	1.40
TOTAL OTHER AREA (SQ. FT.)				
NET PERMIOUS (SQ. FT.):	150,741		Q ALLOW (cfs) =	0.50

(See original Detention Calcs)

Q allowable of 1.77 cfs exceeds the capacity of the existing county storm sewer system, the LCEO has determined a Q allowable of 0.50 cfs is to be used.

TENTION VOLUME CALCULATION

tc (min)	i25 in./hr.	CvA (A=Ac)	Qin Q25	Qout= Qallow	Qin-Qout	xtcx60 (cu. ft.)
200.00	0.87	3.52	3.06	0.50	2.56	30666
210.00	0.84	3.52	2.94	0.50	2.44	30780
220.00	0.81	3.52	2.84	0.50	2.34	30876
230.00	0.78	3.52	2.74	0.50	2.24	30956
240.00	0.75	3.52	2.65	0.50	2.15	31021
250.00	0.73	3.52	2.57	0.50	2.07	31072
260.00	0.71	3.52	2.49	0.50	1.99	31110
270.00	0.69	3.52	2.42	0.50	1.92	31136
280.00	0.67	3.52	2.35	0.50	1.85	31152
290.00	0.65	3.52	2.29	0.50	1.79	31157
300.00	0.63	3.52	2.23	0.50	1.73	31153
310.00	0.62	3.52	2.17	0.50	1.67	31140
320.00	0.60	3.52	2.12	0.50	1.62	31119
330.00	0.59	3.52	2.07	0.50	1.57	31090
340.00	0.57	3.52	2.02	0.50	1.52	31053
350.00	0.56	3.52	1.98	0.50	1.48	31010
360.00	0.55	3.52	1.93	0.50	1.43	30961

Req'd. Volume	31,157
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METERLINE CALCULATIONS

10 Yr HGL Elev. @Outlet	638.18	Manning's n=	0.012	n=0.012 Smooth Wall
Pond Elev. @Req'd Storage	640.30	PIPELENGTH L (FT.) =	23.0	n=0.024 Corrugated Wall
Invert @Meterline Outlet	636.90	PIFEDIA (IN.):	4	
Top/Pipe @Outlet	637.23			
MAX. HEAD =H (FT)	2.12			

MAX HEAD	H ₂ G	1+K _e +29N ^A 2L/R ^A 4/3	V ^A 2	V	AREA OF PIPE (A)	Q _{out} (cfs)
2.12	136.53	4.14	32.99	5.74	0.087	0.50

Note that the spreadsheet uses a method that assumes the outlet is submerged and the pipe area is flowing full.

EXISTING POND HAS THE CAPACITY FOR THE PROPOSED DRAINAGE AREA
AND DOES NOT NEED TO BE MODIFIED.

ORIGINAL SOUTH POND DETENTION CALCULATIONS FOR FULL BUILDOUT FROM 2025 PARKING LOT EXPANSION

Lucas County Engineer's Office
STORMWATER DETENTION DESIGN

BY: Mannik & Smith Group DATE: 10-10-24

PROJECT: Redemption Church Notes: # Build-Out

Grass Areas			Cultivated Areas		
Soil Type	Area	C	Soil Type	Area	C
A	33,082 sf	0.05	D	165,388 sf	0.74
B	2,263 sf	0.16	C	269,590 sf	0.66
C	65,715 sf	0.36	Total	434,978	
D	42,125 sf	0.47			
Total	143,185				
Average C= 0.60					
Enter values pertinent to the site in all non-shaded outlined cells.					
TOTAL AREA (SQ. FT.):	578,163	13,273 Ac.	SITE PERVIOUS C =	0.60	
ALLOWABLE AREA (SQ. FT.):	578,163	13,273 Ac.			
WET POND AREA (SQ. FT.):	20,866	c=1.00	WT. C = Cw =	0.76	
PAVEMENT AREA (SQ. FT.):	176,623	c=0.96			
STONE AREA (SQ. FT.):	0	c=0.75	ALLOW C =	0.60	
BUILDING AREA (SQ. FT.):	53,700	c=0.96			
FUTURE BLDG. AREA (SQ. FT.):		c=0.96	ALLOW Tc (mins.) =	38.9	20 mins Min.
TOTAL IMPERVIOUS (SQ. FT.):	251,189		ALLOW I _s =	2.07	
TOTAL OTHER AREA (SQ. FT.):	0		Q ALLOW (cfs) =	8.31	Allowable Q = 16.50 cfs Meterline Controls
NET PERVIOUS (SQ. FT.):	326,974				

DETENTION VOLUME CALCULATION						
tc (min)	I25 in./hr.	CwA (A=Ac)	Qin Q25	Qout= Qallow	Qin-Qout	xtcx60 (cu. ft.)
20.00	4.11	10.06	41.31	8.31	33.00	39600
30.00	3.27	10.06	32.93	8.31	24.62	44315
40.00	2.74	10.06	27.59	8.31	19.28	46266
50.00	2.37	10.06	23.86	8.31	15.55	46646
60.00	2.10	10.06	21.09	8.31	12.78	46026
70.00	1.88	10.06	18.96	8.31	10.65	44717
80.00	1.71	10.06	17.25	8.31	8.94	42908
90.00	1.58	10.06	15.85	8.31	7.54	40719
100.00	1.46	10.06	14.68	8.31	6.37	38234
110.00	1.36	10.06	13.69	8.31	5.38	35510
120.00	1.28	10.06	12.84	8.31	4.53	32590
130.00	1.20	10.06	12.09	8.31	3.78	29507
140.00	1.14	10.06	11.44	8.31	3.13	26286
150.00	1.08	10.06	10.86	8.31	2.55	22946
160.00	1.03	10.06	10.34	8.31	2.03	19504
170.00	0.98	10.06	9.88	8.31	1.57	15971
180.00	0.94	10.06	9.45	8.31	1.14	12359

Req'd. Volume 46,646

METERLINE CALCULATIONS

10 Yr HGL Elev. @Outlet	637.25	Manning's n=	0.012	n= 0.012 Smooth Wall
Pond Elev. @Req'd. Storage	639.39			n= 0.024 Corrugated Wall
Invert @Meterline Outlet	636.50	PIPE LENGTH L (FT.) =	41.0	
Top Pipe @Outlet	637.75	PIPE DIA (IN.):	15	
MAX HEAD = H (FT)	1.64			

MAX. HEAD	Hx2G	$1+K_e+29N^4 \frac{2L}{R^4/3}$	V^2	V	AREA OF PIPE (A)	Q out (cfs)
1.64	105.87	2.31	45.88	6.77	1.227	8.31

Note that the spreadsheet uses a method that assumes the outlet is submerged and the pipe area is flowing full.

UPDATED SOUTH POND DETENTION CALCULATIONS PER PROPOSED IMPROVEMENTS

Lucas County Engineer's Office
STORMWATER DETENTION DESIGN

BY: Mannik & Smith Group DATE: 10-15-25

PROJECT: Redemption Church Notes: Rear Pond

Grass Areas			Cultivated Areas		
Soil Type	Area	C	Soil Type	Area	C
A	31,805 sf	0.05	D	##### sf	0.74
B	0 sf	0.16	C	##### sf	0.66
C	51,074 sf	0.36	Total	#####	
D	29,010 sf	0.47			
Total	111,889				
Average C = 0.62					
Enter values pertinent to the site in all non-shaded outlined cells.					
TOTAL AREA (SQ. FT.):	542,903	12,463 Ac.	SITE PERVIOUS C =	0.62	
ALLOWABLE AREA (SQ. FT.):	542,903	12,463 Ac.			
WET POND AREA (SQ. FT.):	20,867	c=1.00	WT. C = Cw=	0.66	
PAVEMENT AREA (SQ. FT.):	37,501	c=0.96			
STONE AREA (SQ. FT.):	0	c=0.75	ALLOW C =	0.62	
BUILDING AREA (SQ. FT.):	10,040	c=0.96			
FUTURE BLDG. AREA (SQ. FT.):		c=0.96	ALLOW Tc (mins.) =	38.9	20 mins Min.
TOTAL IMPERVIOUS (SQ. FT.):	68,408		ALLOW I _s =	2.07	
TOTAL OTHER AREA (SQ. FT.):	0		Q ALLOW (cfs) =	8.31	Allowable Q = 16.50 cfs Meterline Controls
NET PERVIOUS (SQ. FT.):	474,495				

DETENTION VOLUME CALCULATION						
tc (min)	I25 in./hr.	CwA (A=Ac)	Qin Q25	Qout= Qallow	Qin-Qout	xtcx60 (cu. ft.)
20.00	4.11	8.28	34.01	8.31	25.70	30836
30.00	3.27	8.28	27.11	8.31	18.80	33835
40.00	2.74	8.28	22.71	8.31	14.40	34560
50.00	2.37	8.28	19.64	8.31	11.33	33991
60.00	2.10	8.28	17.37	8.31	9.06	32599
70.00	1.88	8.28	15.61	8.31	7.30	30640
80.00	1.71	8.28	14.20	8.31	5.89	28269
90.00	1.58	8.28	13.05	8.31	4.74	25586
100.00	1.46	8.28	12.09	8.31	3.78	22659
110.00	1.36	8.28	11.27	8.31	2.96	19535
120.00	1.28	8.28	10.57	8.31	2.26	16250
130.00	1.20	8.28	9.95	8.31	1.64	12830
140.00	1.14	8.28	9.42	8.31	1.11	9297
150.00	1.08	8.28	8.94	8.31	0.63	5667
160.00	1.03	8.28	8.51	8.31	0.20	1951
170.00	0.98	8.28	8.13	8.31	-0.18	-1839
180.00	0.94	8.28	7.78	8.31	-0.53	-5694

Req'd. Volume 34,560

METERLINE CALCULATIONS						
10 Yr HGL Elev. @Outlet		637.25	Manning's n=		0.012	n=0.012 Smooth Wall
Pond Elev. @Req'd. Storage		639.39				n=0.024 Corrugated Wall
Invert @Meterline Outlet		636.50	PIPE LENGTH L (FT.) =		41.0	
Top Pipe @Outlet		637.75	PIPE DIA (IN.):		15	
MAX HEAD = H (FT.)		1.64				
MAX HEAD	Hx2G	$1+K_e+29N^4$ $2L/R^4/3$	V^2	V	AREA OF PIPE (A)	Q out (cfs)
1.64	105.87	2.31	45.88	6.77	1.227	8.31

Note that the spreadsheet uses a method that assumes the outlet is submerged and the pipe area is flowing full.

ORIGINAL SOUTH POND DETENTION REQUIRED = 46,646 CF
PROPOSED NORTH POND DETENTION REQUIRED = 34,560 CF

EXISTING POND HAS THE CAPACITY FOR THE PROPOSED DRAINAGE AREA
AND DOES NOT REQUIRE MODIFICATION.

DESCRIPTION

ISSUED FOR PERMITS

BY

DATE

NO.

1800 INDIAN WOOD CIRCLE
MASON, OH 45040
TEL: 419.881.1922
FAX: 419.881.1595

PROJECT DATE: 06/11/2025
PROJECT NO: 250745
DRAWN BY: JEC
CHECKED BY: MJM

TECHNICAL SKILL-
CREATIVE SPIRIT.


Mannik
Smith
GROUP
www.MannikSmithGroup.com


PREPARED FOR:
REDEMPTION
CHURCH
202 WEST MAIN STREET
MASON, OH 45040

REDEMPTION CHURCH
SPECIAL FUNCTION
ACCESSORY BUILDING
8605 SALISBURY ROAD
MONCLOVA, OH 43042



SOUTH POND
DETENTION CALCS


C450


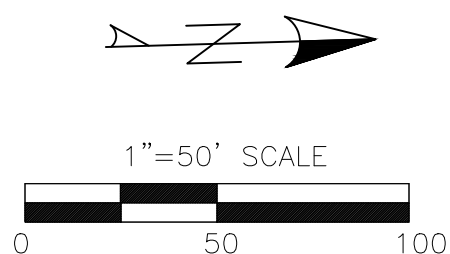


C460	STORM PIPING DRAINAGE MAP	REDEMPTION CHURCH SPECIAL FUNCTION ACCESSORY BUILDING 8605 SAUSBURY ROAD MONCLOVA, OH 43542	PREPARED FOR: REDEMPTION CHURCH 202 WEST MAIN STREET MASON, OH 45440	 Mannik Smith GROUP www.MannikSmithGroup.com	TECHNICAL SKILL: CREATIVE SPIRIT.	1800 INDIAN WOOD CIRCLE MAUMEE, OH 43537 TEL: 419.881.2222 FAX: 419.881.1350	NO.	DATE	BY	DESCRIPTION
							1	10/02/2025	JEC	ISSUED FOR PERMITS
							2	12/04/2025	JEC	MONCLOVA TOWNSHIP SUBMITTAL
						PROJECT DATE: 06/11/2025				
						PROJECT NO: 2500745				
						DRAWN BY: JEC				
						CHECKED BY: NMM				

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C470	SANITARY PLAN & PROFILE	REDEMPTION CHURCH SPECIAL FUNCTION ACCESSORY BUILDING 8605 SALISBURY ROAD MONCLOVA, OH 43542	PREPARED FOR: REDEMPTION CHURCH 202 WEST MAIN STREET MASON, OH 45040	<div><div>TECHNICAL SKILL. CREATIVE SPIRIT.</div><div>www.MannikSmithGroup.com</div></div>	<table><tr><th>NO.</th><th>DATE</th><th>BY</th><th>DESCRIPTION</th></tr><tr><td>1</td><td>10/30/2025</td><td>JEC</td><td>ISSUED FOR PERMITS</td></tr><tr><td>2</td><td>12/24/2025</td><td>JEC</td><td>MONCLOVA TOWNSHIP SUBMITTAL</td></tr><tr><td> </td><td> </td><td> </td><td> </td></tr><tr><td> </td><td> </td><td> </td><td> </td></tr><tr><td> </td><td> </td><td> </td><td> </td></tr><tr><td> </td><td> </td><td> </td><td> </td></tr><tr><td> </td><td> </td><td> </td><td> </td></tr><tr><td> </td><td> </td><td> </td><td> </td></tr><tr><td> </td><td> </td><td> </td><td> </td></tr><tr><td> </td><td> </td><td> </td><td> </td></tr><tr><td> </td><td> </td><td> </td><td> </td></tr><tr><td> </td><td> </td><td> </td><td> </td></tr><tr><td> </td><td> </td><td> </td><td> </td></tr><tr><td> </td><td> </td><td> </td><td> </td></tr><tr><td> </td><td> </td><td> </td><td> </td></tr><tr><td> </td><td> </td><td> </td><td> </td></tr><tr><td> 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STORM SEWER DRAINAGE CALCULATIONS															n = 0.012 HDPE				n = 0.013 (concrete/Pipe)					
STRUCTURE		Drainage Area #	IMPERVIOUS	PERVIOUS	TOTAL	C	A Acres	CA	Cum. CA	Tc MIN	I IN/HR	Q CFS	SIZE IN	LENGTH FT	RIM	Cover At Rim	H INV FT	L INV FT	So	Qpipe CFS	Vf FT/S	Tt MIN	Slope x Distance	
FROM	TO																							
RUN 1																								
	CB3	CB2	1	3892	1290	5182	0.76	0.12	0.091	0.09	20.0	3.16	0.29	12	47	640.50	2.00	637.50	637.33	0.37%	2.34	3.0	0.3	0.01
	CB2	CB1	2	347	909	1256	0.38	0.03	0.011	0.10	20.3	3.14	0.32	12	41	641.00	2.67	637.33	637.17	0.37%	2.34	3.0	0.2	0.01
BLD1	TEE	4	2785	0	2785	0.96	0.06	0.061	0.06	10.0	4.30	0.26	6	62	642.20	3.46	638.24	637.62	1.00%	0.61	3.1	0.3	0.19	
BLD2	TEE	5	2869	0	2869	0.96	0.07	0.063	0.06	10.0	4.30	0.27	6	189	642.20	2.20	639.50	637.62	1.00%	0.61	3.1	1.0	0.20	
TEE	CB1								0.12	11.0	4.16	0.52	6	26	642.42	4.30	637.62	637.23	1.50%	0.74	3.8	0.1	0.72	
CB1	POND	3	577	671	1248	0.53	0.03	0.015	0.24	20.5	3.12	0.75	12	59	641.00	2.83	637.17	636.96	0.37%	2.34	3.0	0.3	0.04	
RUN 2																								
FINAL BUILDOUT																								
BLDG REDUCER	REDUCER CB4	6	10040	0	10040	0.96	0.23	0.221	0.22	10.0	4.30	0.95	8	135	642.20	2.83	638.70	637.35	1.00%	1.30	3.7	0.6	0.53	
									0.22	10.6	4.22	0.93	12	107			637.35	636.71	0.60%	2.98	3.8	0.5	0.06	
FUTURE	CB4	7	63635	3088	66723	0.92	1.53	1.414	1.41															
CB5	POND	8	17762	3360	21122	0.83	0.48	0.404	2.04	20.0	3.16	6.44	18	270	640.25	2.04	636.71	634.68	0.75%	9.85	5.6	0.8	0.32	
CURRENT PHASE																								
SWALE	CB4		10040	20121	30161	0.43	0.69	0.295	0.30	20.0	3.16	0.93	12	107	639.85	1.50	637.35	636.71	0.60%	2.98	3.8	0.5	0.06	
CB4	POND		0	14233	14233	0.16	0.33	0.052	0.35	20.0	3.16	1.10	18	270	640.25	2.04	636.71	634.68	0.75%	9.85	5.6	0.8	0.01	

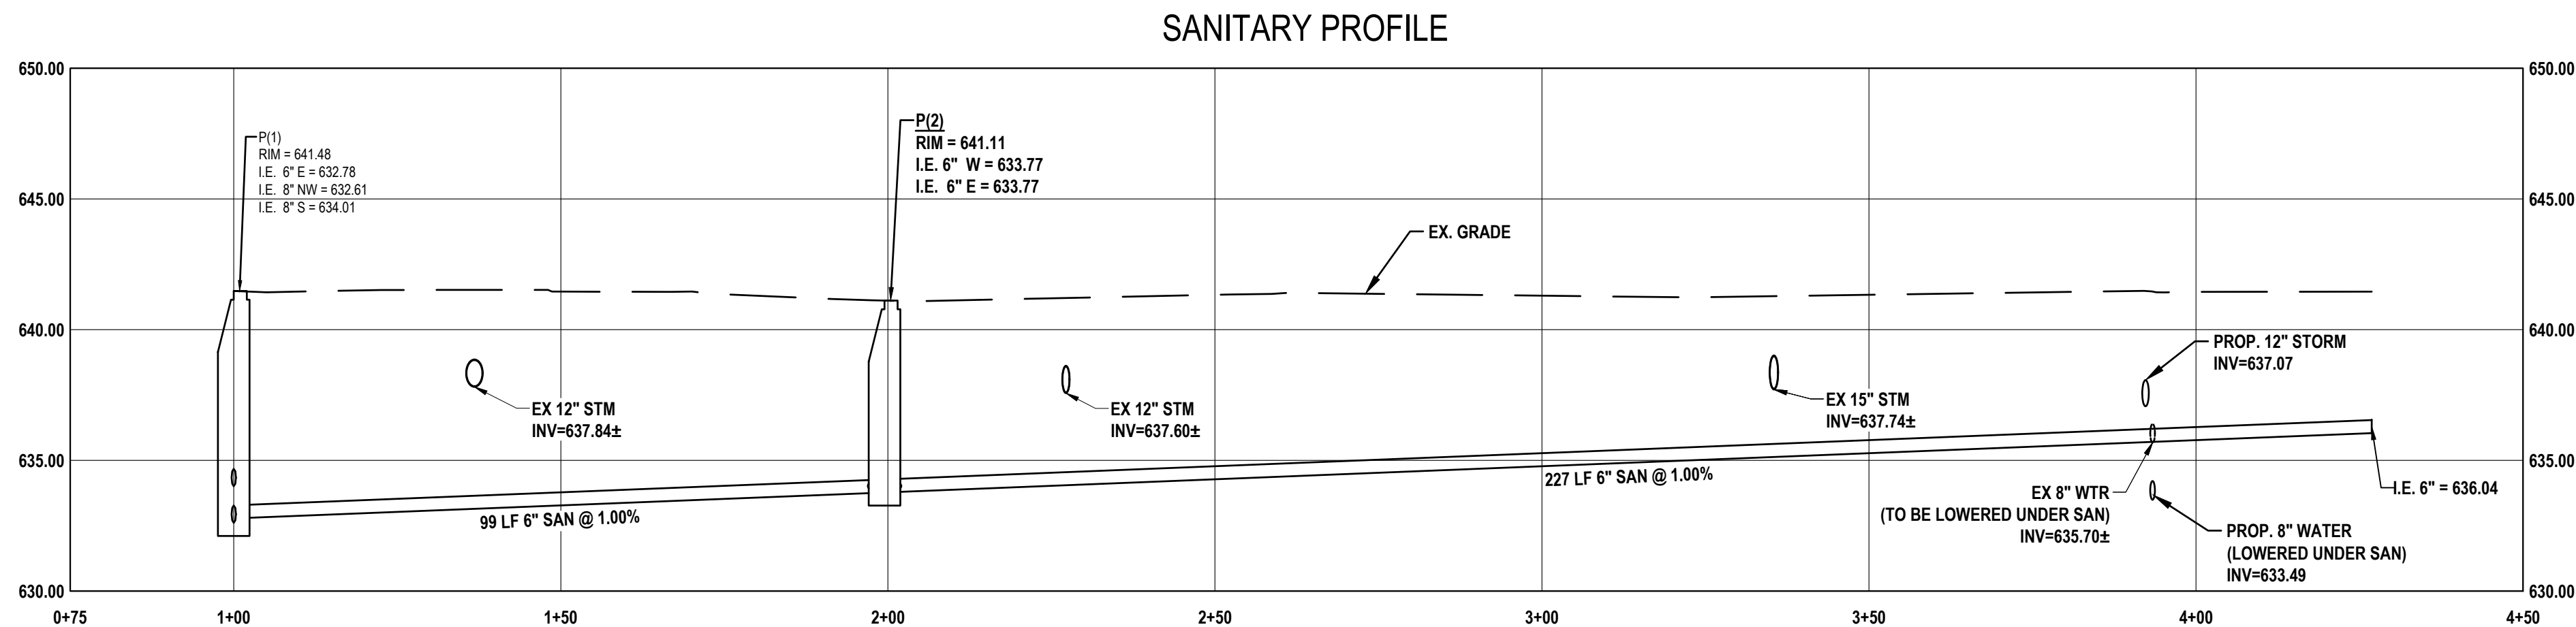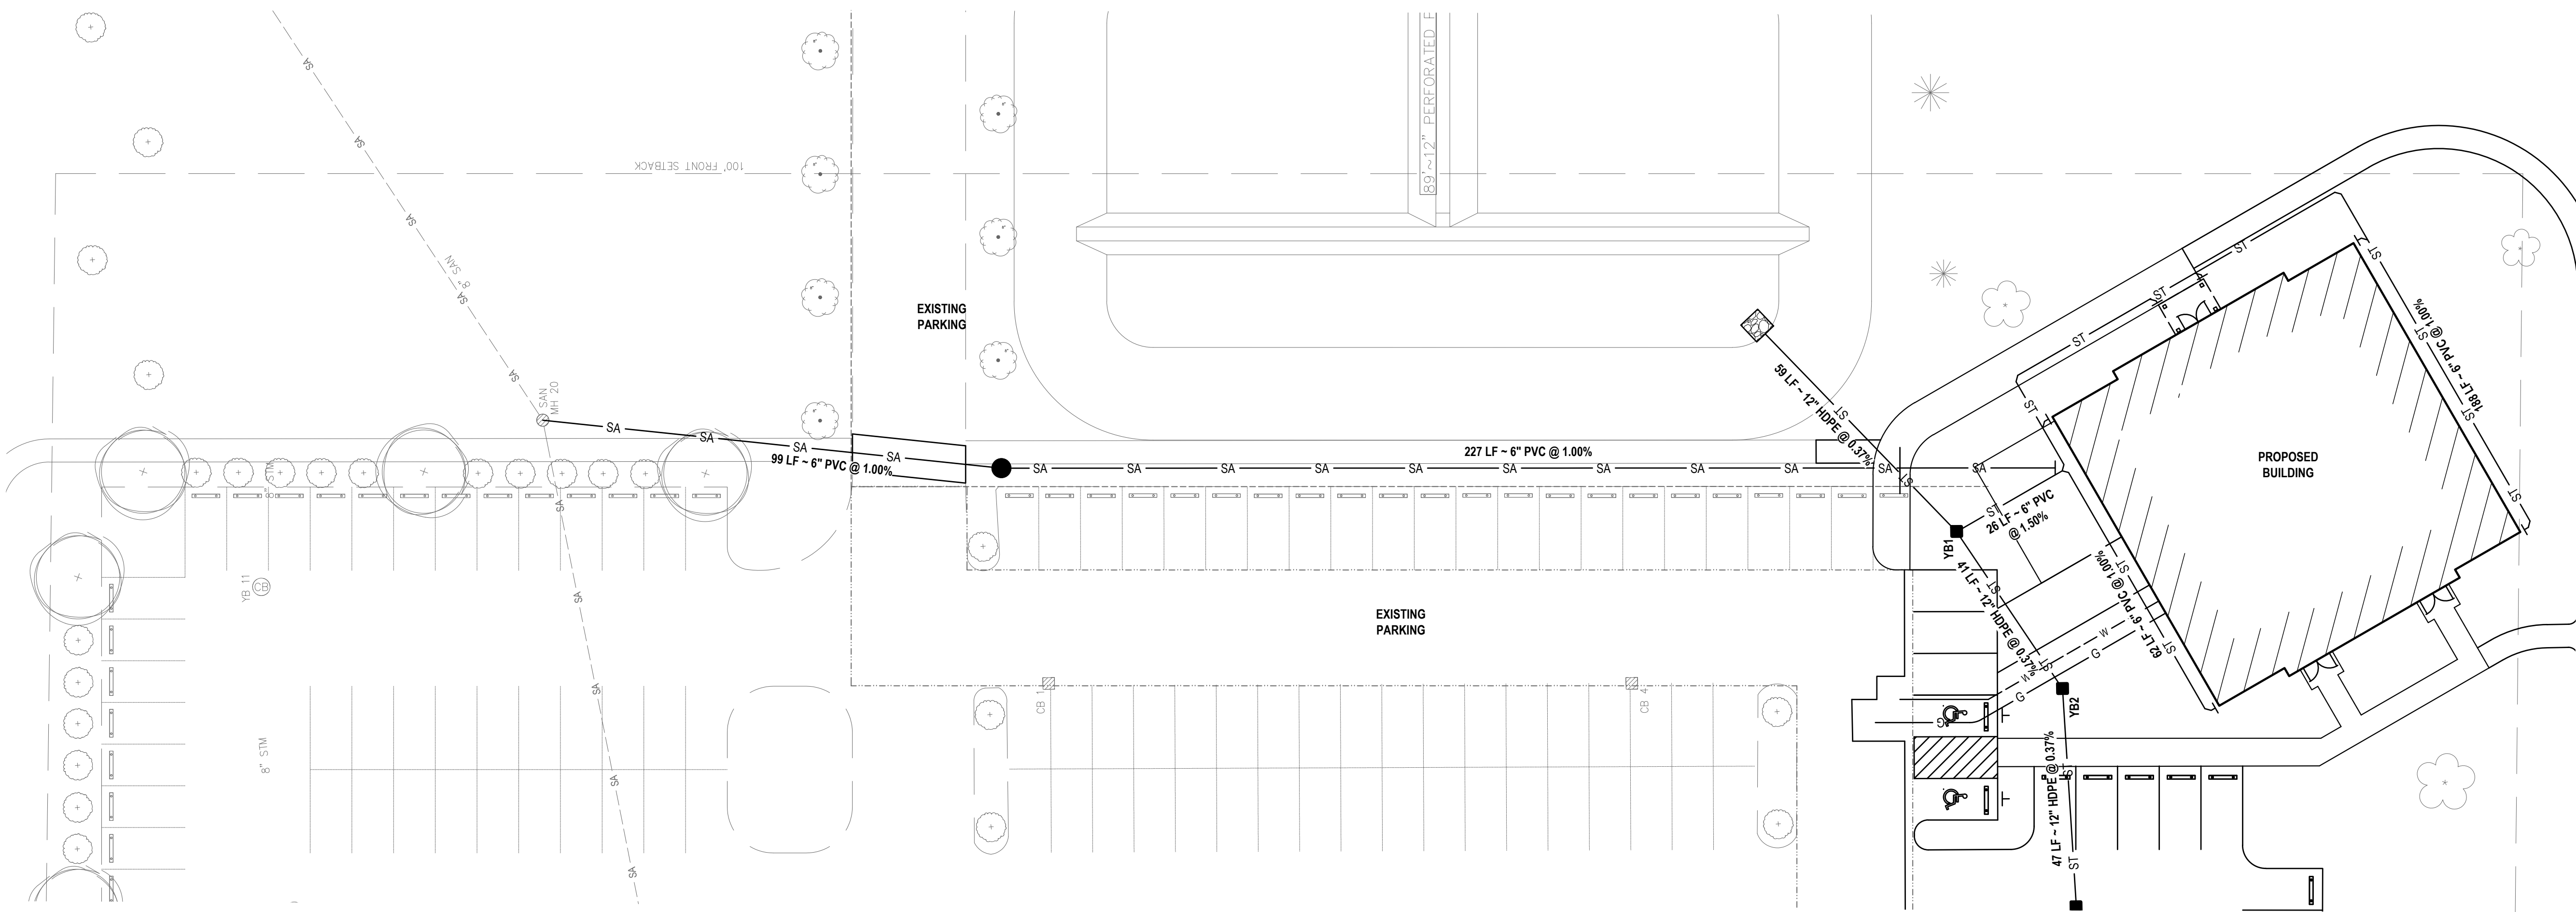[illegible]

**TECHNICAL SKILL.
CREATIVE SPIRIT.**

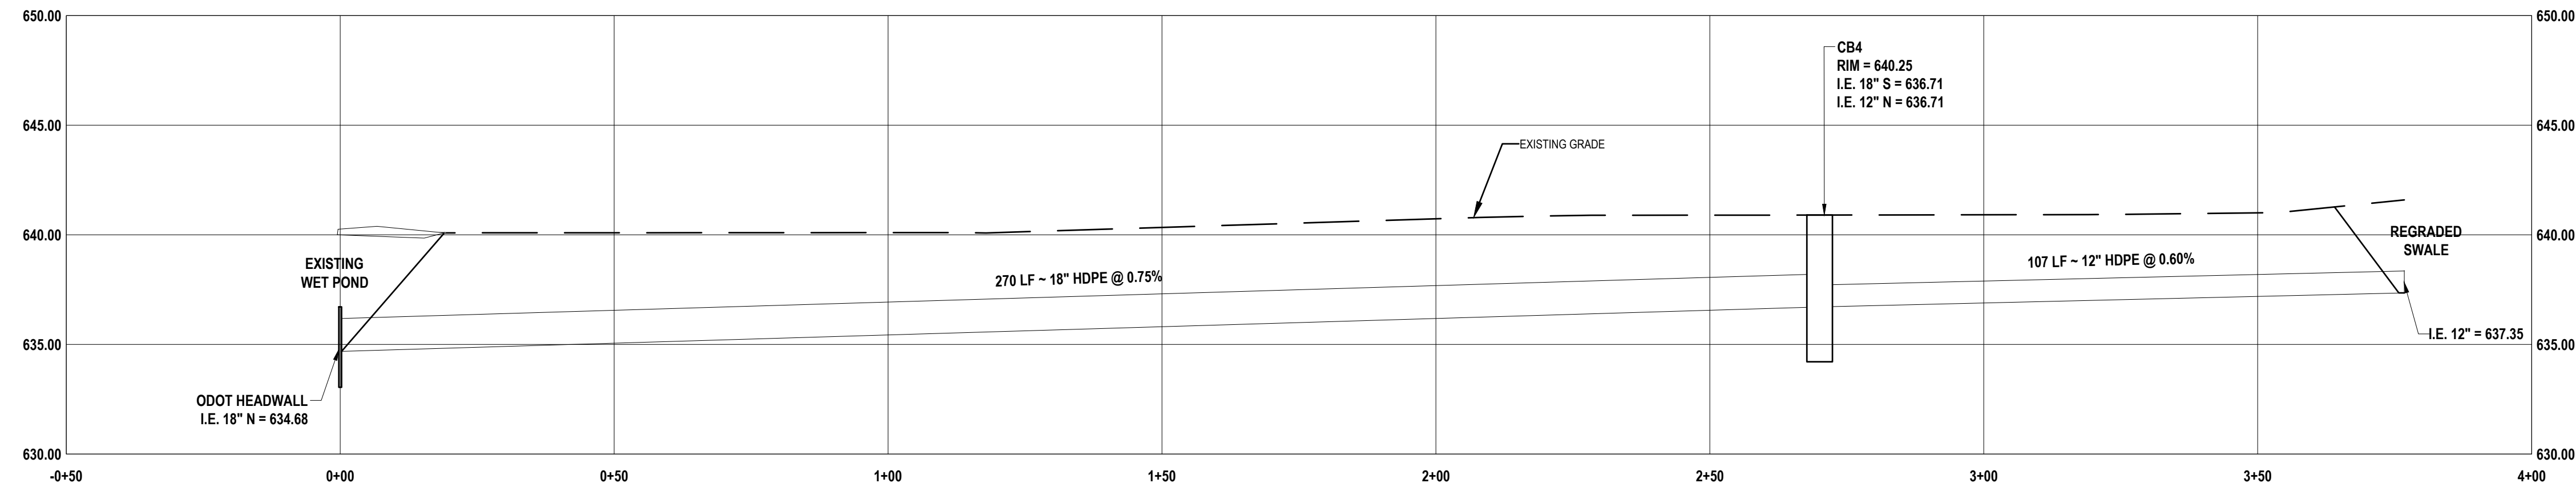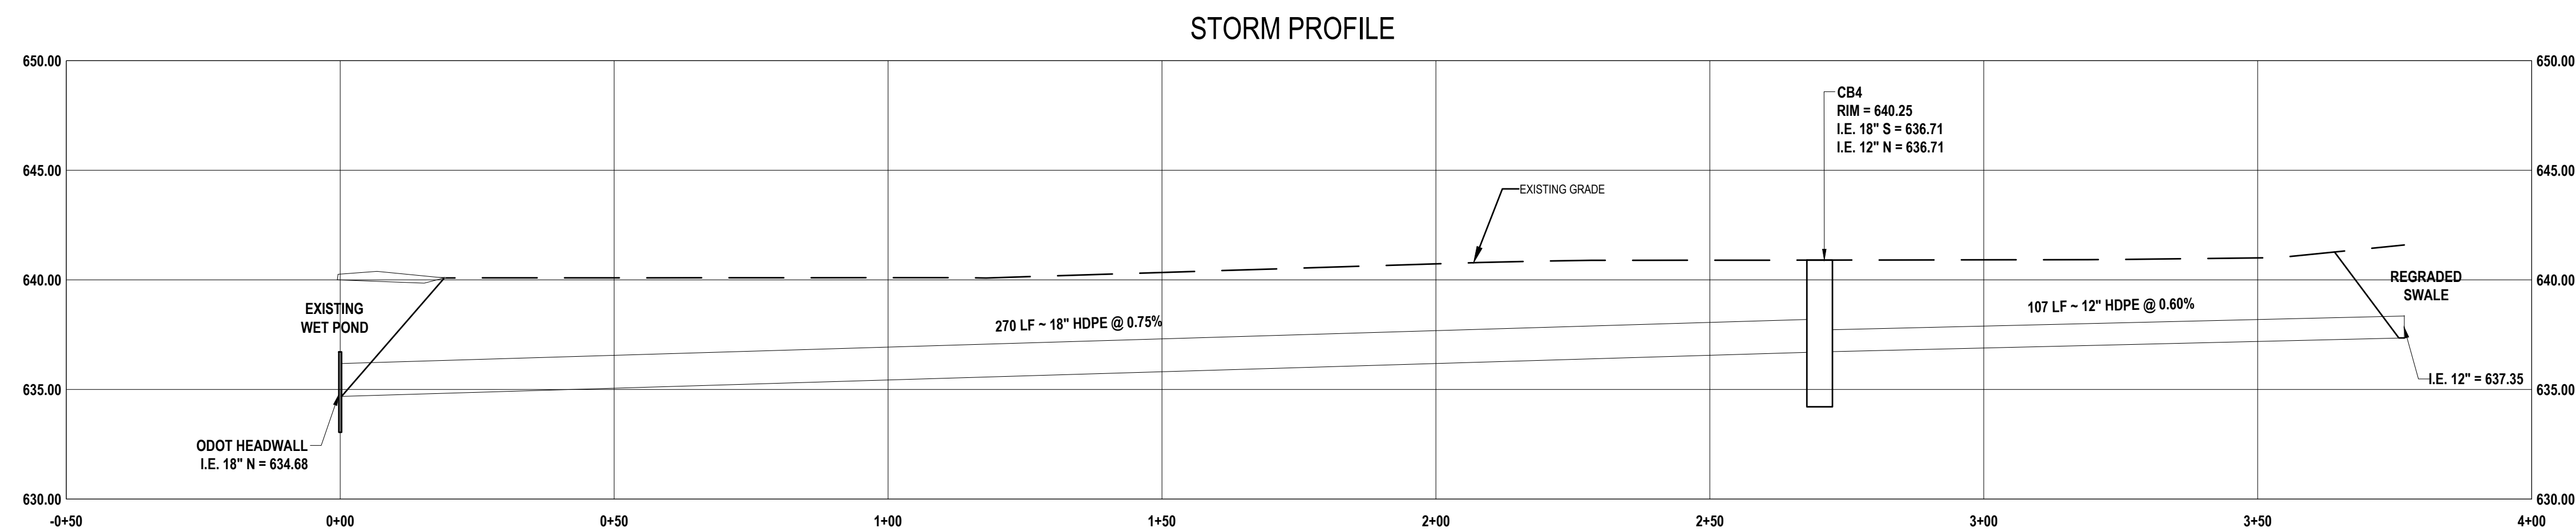


PREPARED FOR:
**REDEMPTION
CHURCH**
202 WEST MAIN STREET
MASON, OH 45040

REDEMPTION CHURCH
SPECIAL FUNCTION
ACCESSORY BUILDING

STORM PROFILES


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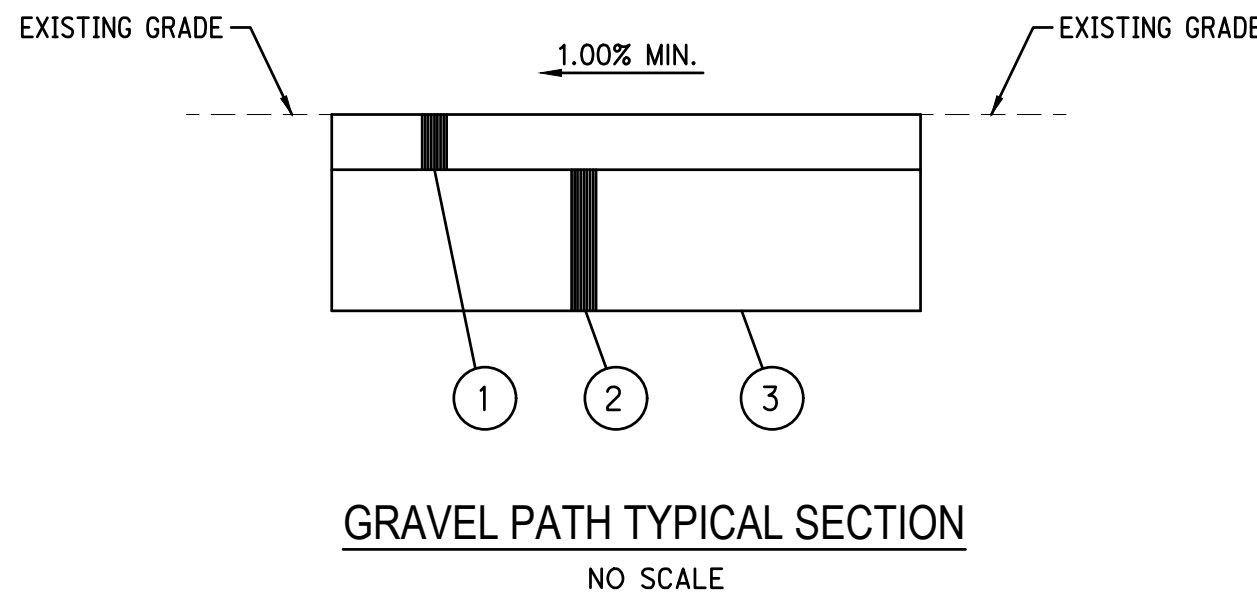
- 1 ODOT ITEM 441.02 1 1/4" ASPHALT CONCRETE SURFACE COURSE, TYPE 1, (449) PG 64-22
- 2 ODOT ITEM 407 TRACKLESS TACK, SURFACE COURSE (0.075 GAL/SQ. YD.)
- 3 ODOT ITEM 441.02 1 3/4" ASPHALT CONCRETE INTERMEDIATE COURSE, TYPE 2, (449) PG 64-22
- 4 ODOT ITEM 304 8" AGGREGATE BASE, (2 EQUAL LAYERS)
- 5 ODOT ITEM 204 SUBGRADE COMPACTION

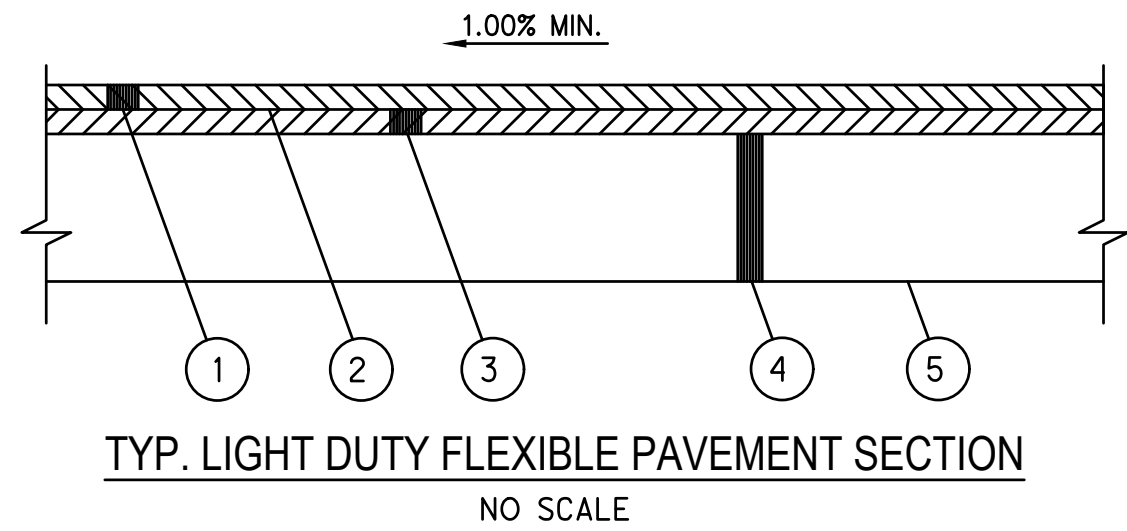OWNER IS RESPONSIBLE FOR HIRING AN INDEPENDENT TESTING AGENCY TO ESTABLISH AN APPROPRIATE COMPACTION RATE BASED ON THE EXISTING SUBGRADE AND SOILS. THE OWNER IS RESPONSIBLE FOR TESTING DURING CONSTRUCTION TO VERIFY THAT THE COMPACTION RATE IS ACHIEVED.

COORDINATE WITH GEOTECHNICAL ENGINEER FOR SUBGRADE PREPARATION.




- 1 ODOT ITEM 608 4" - CONCRETE SIDEWALK
- 2 ODOT ITEM 304 4" AGGREGATE BASE
- 3 ODOT ITEM 204 SUBGRADE COMPACTION
- NOTE: TOOLED JOINTS ONLY, NO SAWCUTS

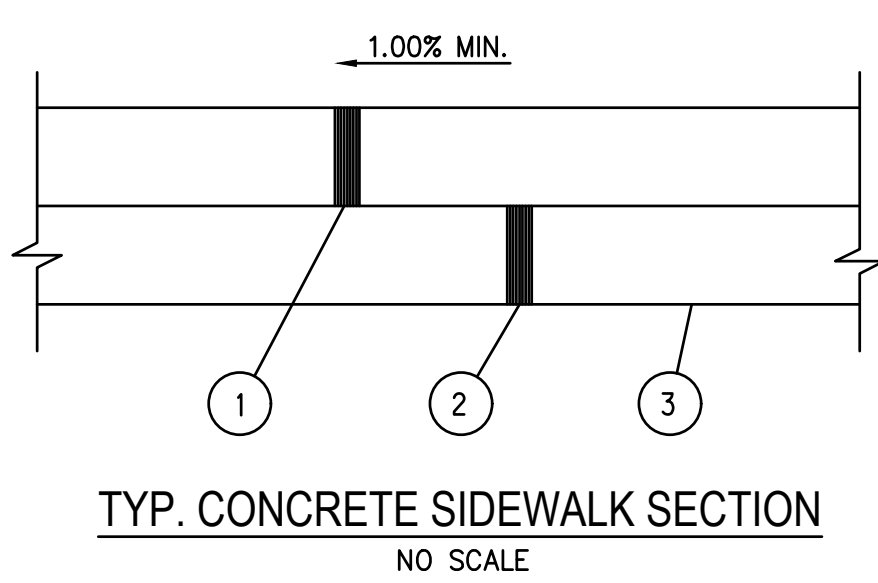


- 1 ODOT ITEM 703.10 2" #10 SCREENINGS
- 2 ODOT ITEM 304 4" AGGREGATE BASE
- 3 ODOT ITEM 204 SUBGRADE COMPACTION

OWNER IS RESPONSIBLE FOR HIRING AN INDEPENDENT TESTING AGENCY TO ESTABLISH AN APPROPRIATE COMPACTION RATE BASED ON THE EXISTING SUBGRADE AND SOILS. THE OWNER IS RESPONSIBLE FOR TESTING DURING CONSTRUCTION TO VERIFY THAT THE COMPACTION RATE IS ACHIEVED.

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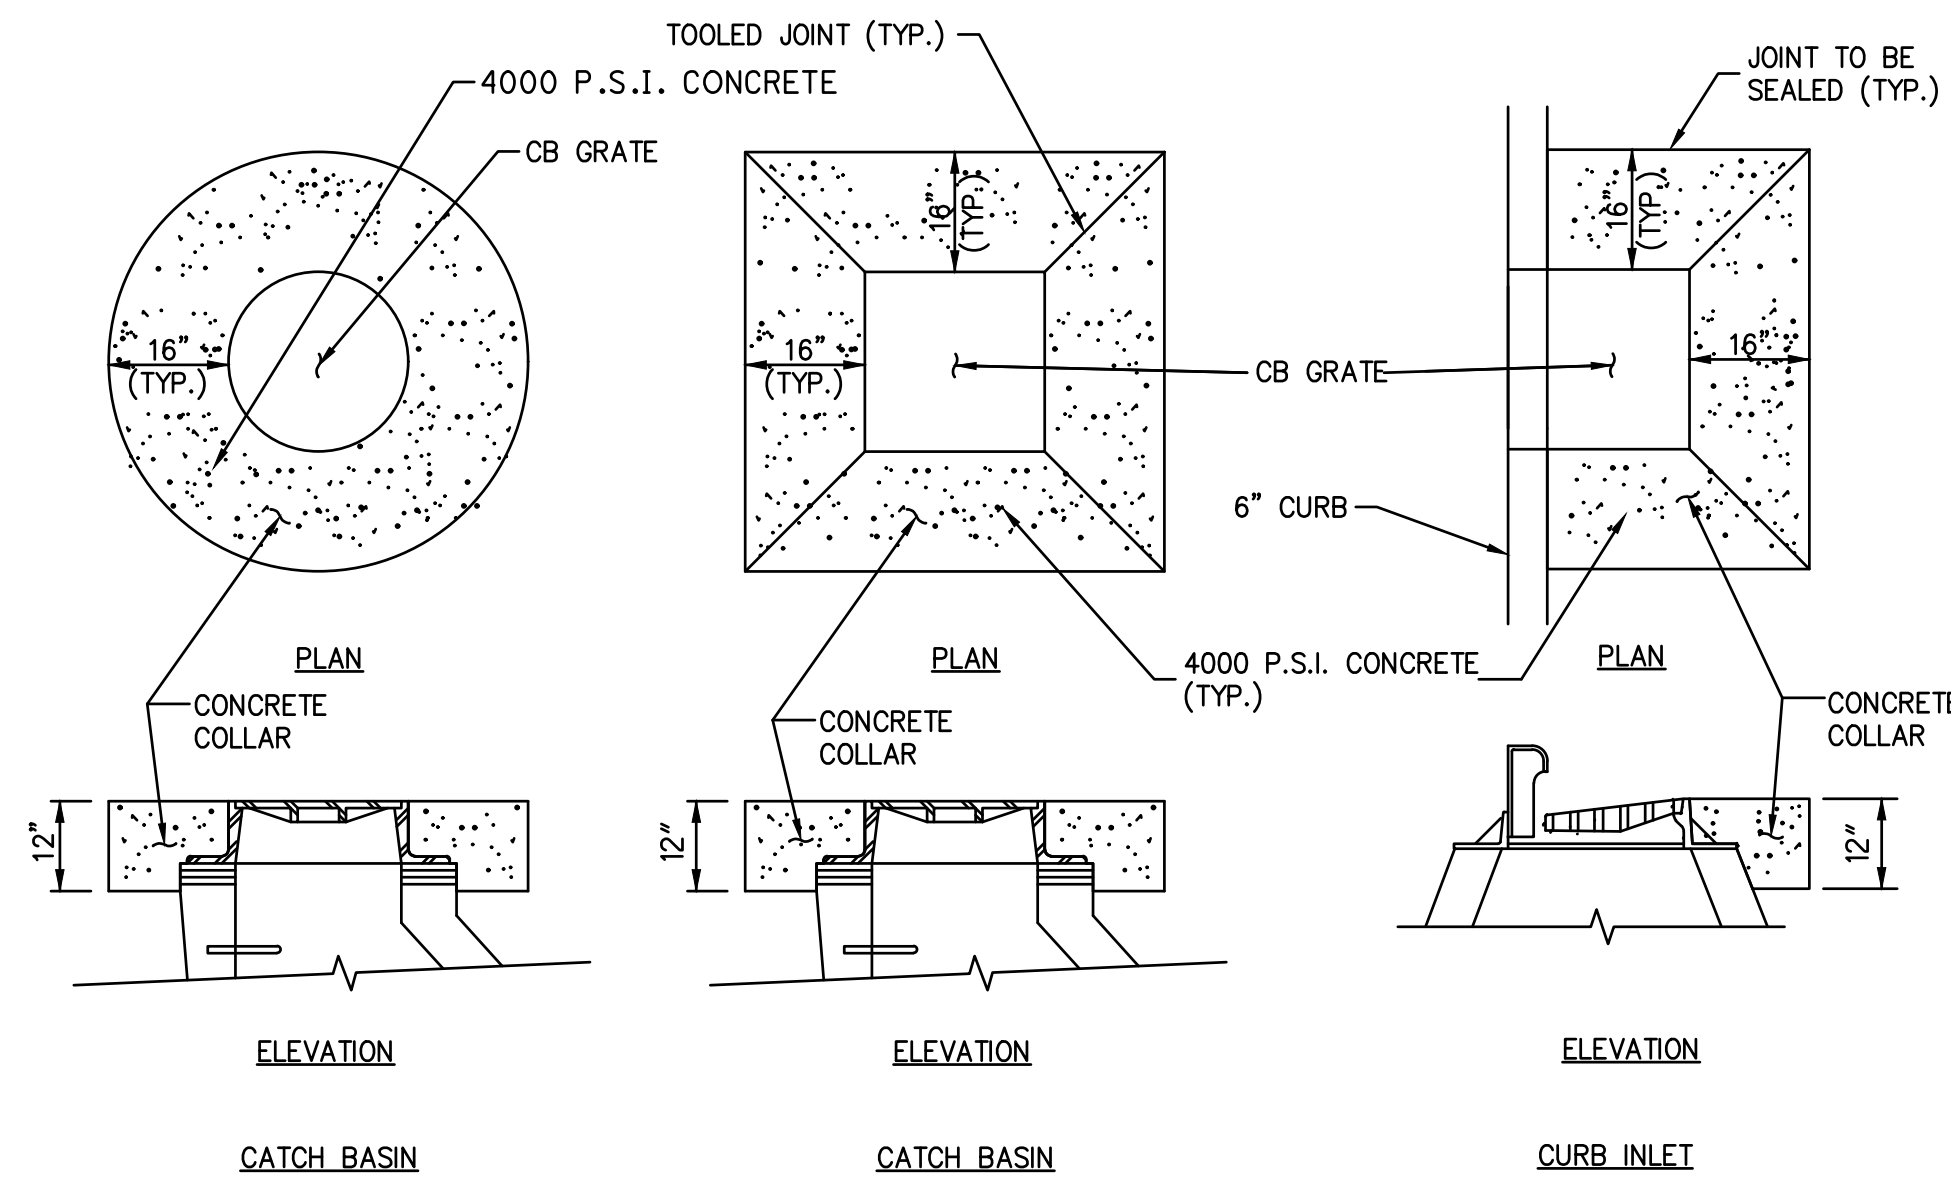


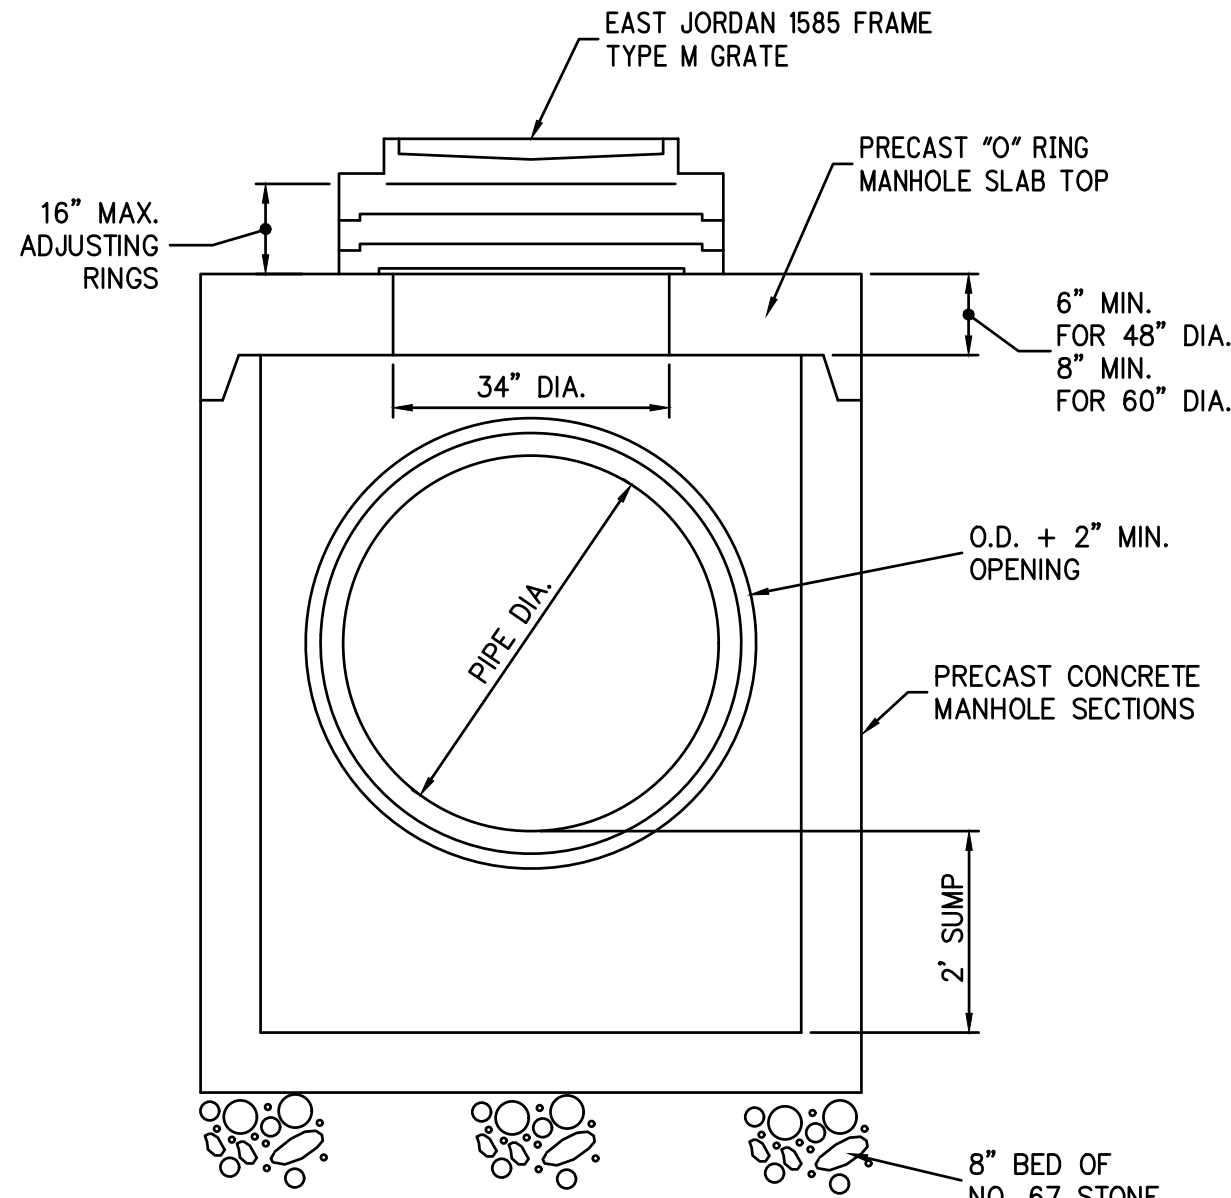FLAT TOP CATCH STRUCTURE DETAIL
NO SCALE

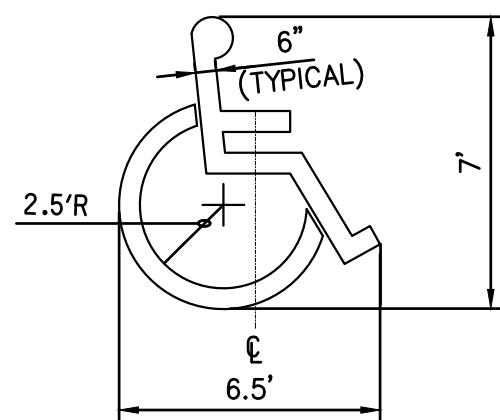


ACCESSIBLE
PARKING SYMBOL

LOCATE AT EDGE OF PARKING SPACE UNLESS ACCOMPANIED BY "VAN" LETTERING




CONCRETE COLLAR DETAIL
NO SCALE

CONCRETE COLLAR SHALL BE PLACED AROUND ALL STRUCTURES CONSTRUCTED IN PAVEMENT AREA.

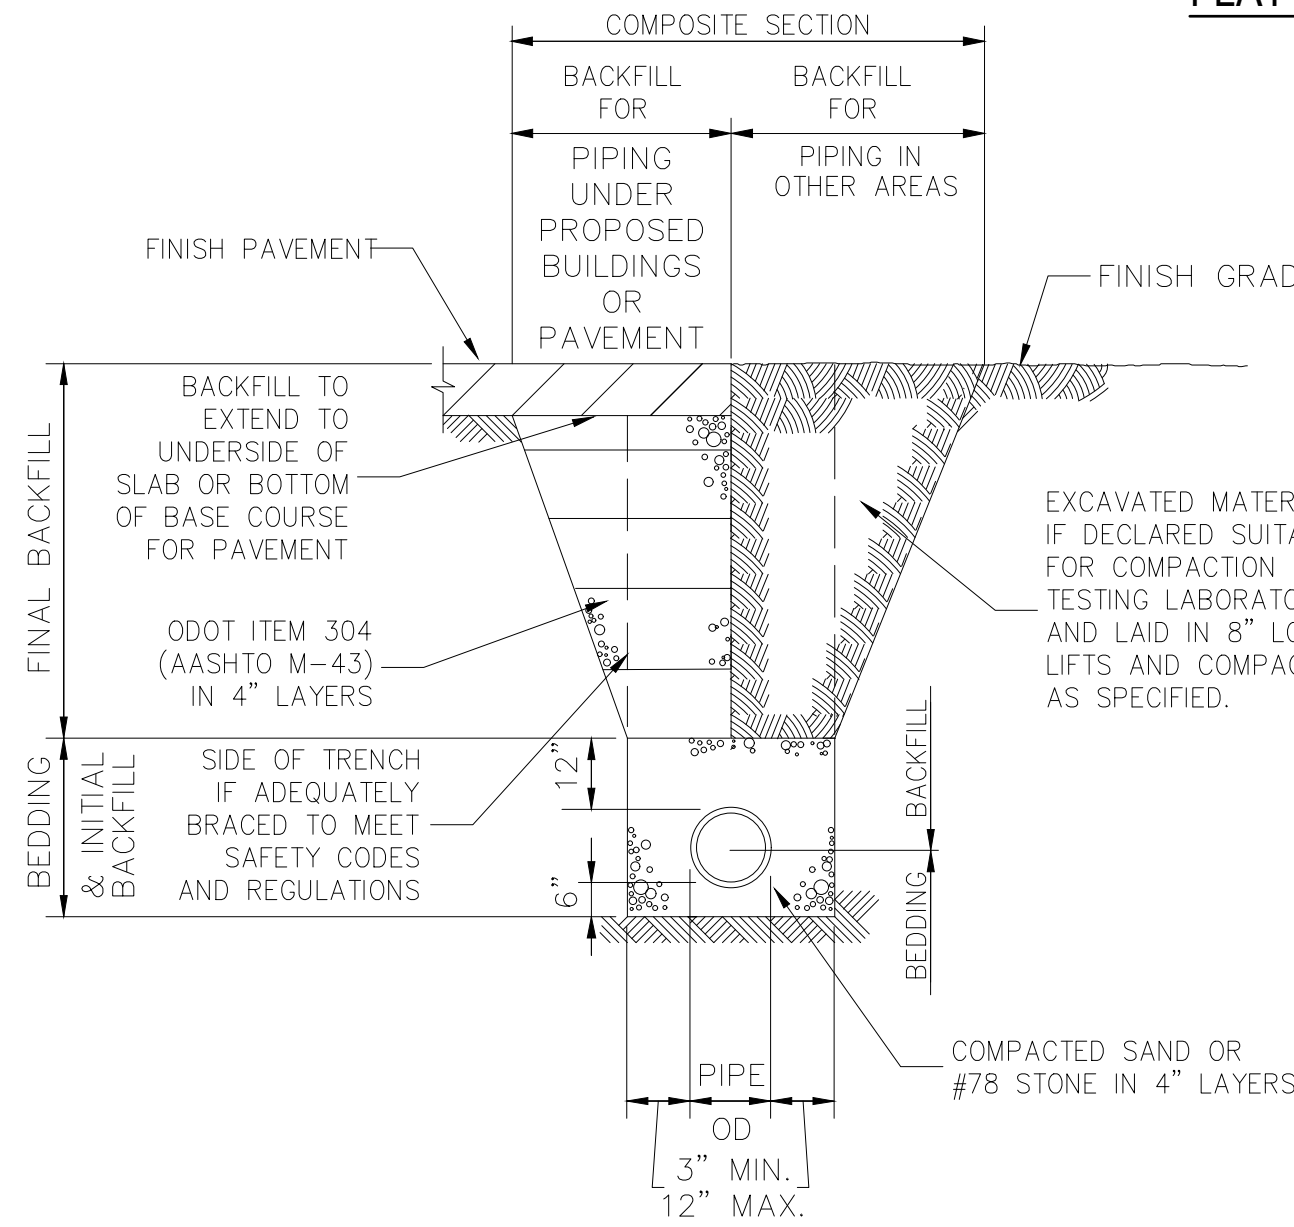


PIPE BEDDING & BACKFILL DETAIL
NO SCALE

ALL SIGNS SHALL COMPLY WITH U.S. DEPARTMENT OF TRANSPORTATION, FEDERAL HIGHWAY ADMINISTRATION'S "MANUAL OF UNIFORM TRAFFIC CONTROL DEVICES", LOCAL CODES AND AS SPECIFIED. MOUNT SIGNS TO POST IN ACCORDANCE WITH MANUFACTURER'S INSTRUCTIONS.

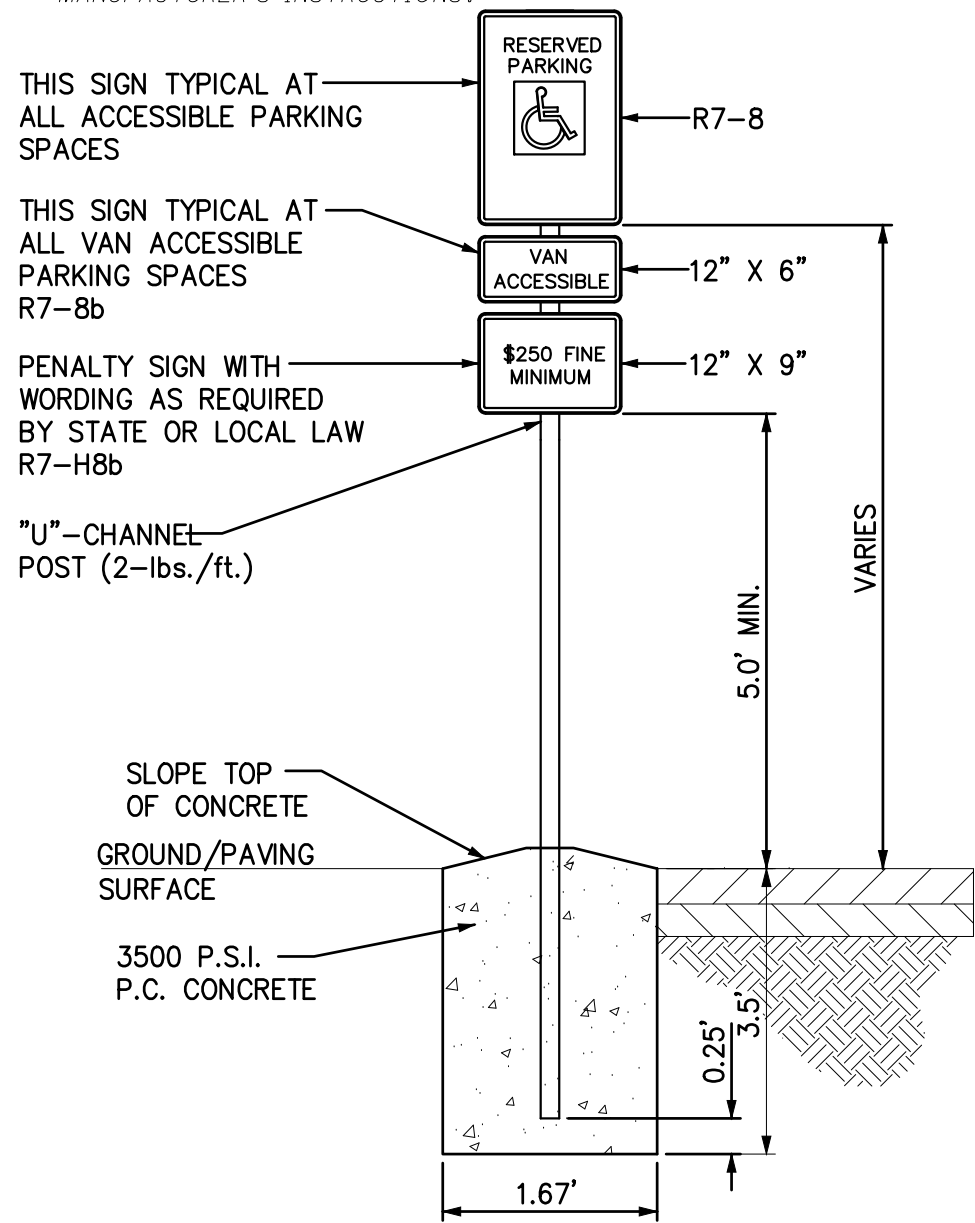

HANDICAP PARKING SIGN DETAIL
NO SCALE

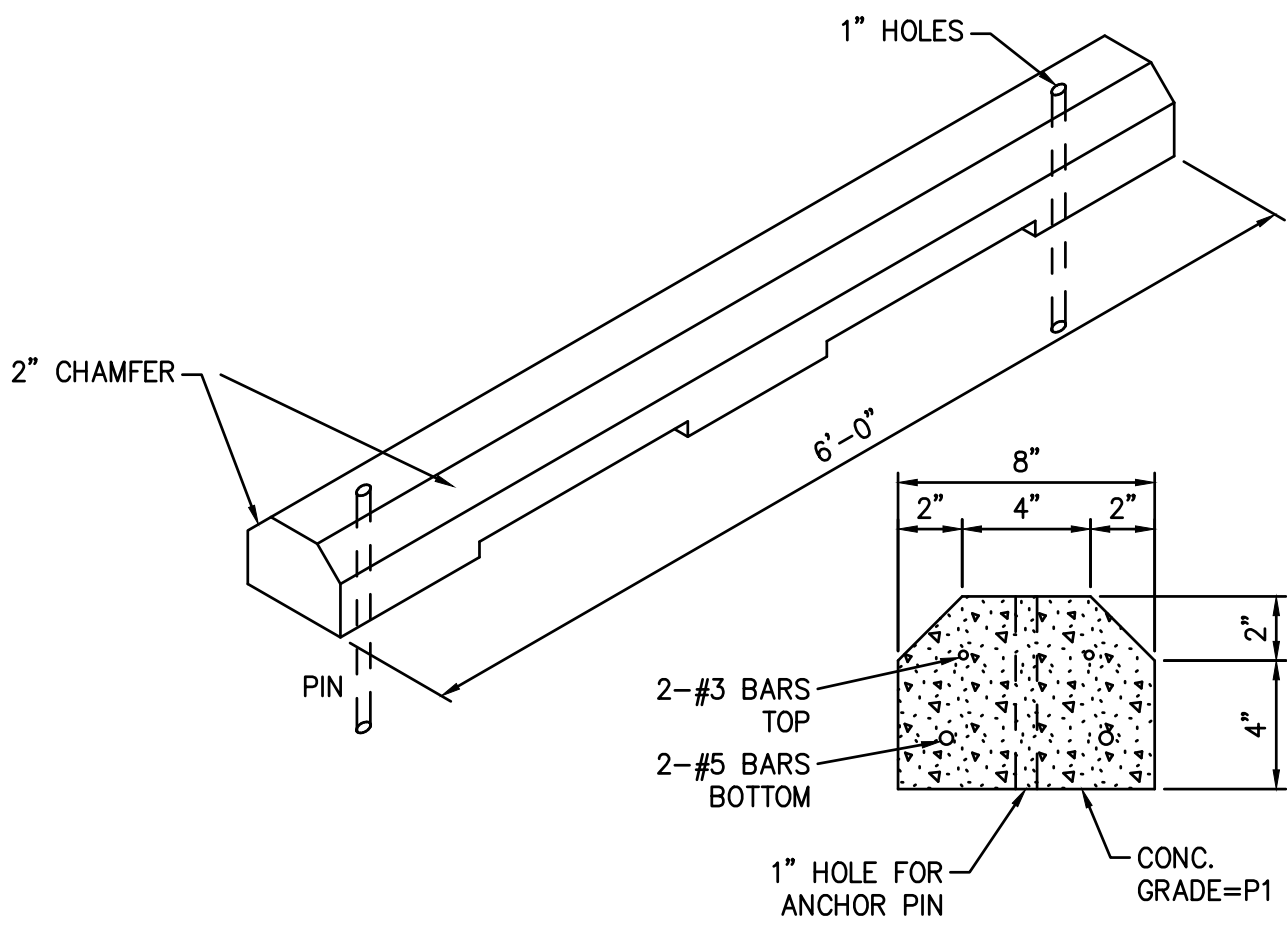

PRECAST PARKING BLOCK
REINFORCED CONCRETE CONSTRUCTION TO BE INSTALLED WITH 3/4"X18" STEEL PINS AS SHOWN

NO.	DATE	BY	DESCRIPTION
1	10/30/2025	JEC	ISSUED FOR PERMITS
2	12/24/2025	JEC	MONCLOVA TOWNSHIP SUBMITTAL

1800 INDIAN WOOD CIRCLE MASON, OH 45040 TEL: 419.881.2222 FAX: 419.881.1595	PROJECT DATE: 06/11/2025 PROJECT NO.: 250745 DRAWN BY: JEC CHECKED BY: MJM
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TECHNICAL SKILL.
CREATIVE SPIRIT.

Mannik Smith Group

www.MannikSmithGroup.com

PREPARED FOR:
REDEMPTION CHURCH
202 WEST MAIN STREET
MASON, OH 45040


**REDEMPTION CHURCH
SPECIAL FUNCTION
ACCESSORY BUILDING**

8605 SALISBURY ROAD
MONCLOVA, OH 43042

DETAIL SHEET

C500

\\Project\2025\600-789\2007\SC\SHS\SWPPP\SWPPP PLAN.dwg, last saved: 10/30/2025, 3:58 PM by JCoak, plottest 12/13/2025 12:49 AM

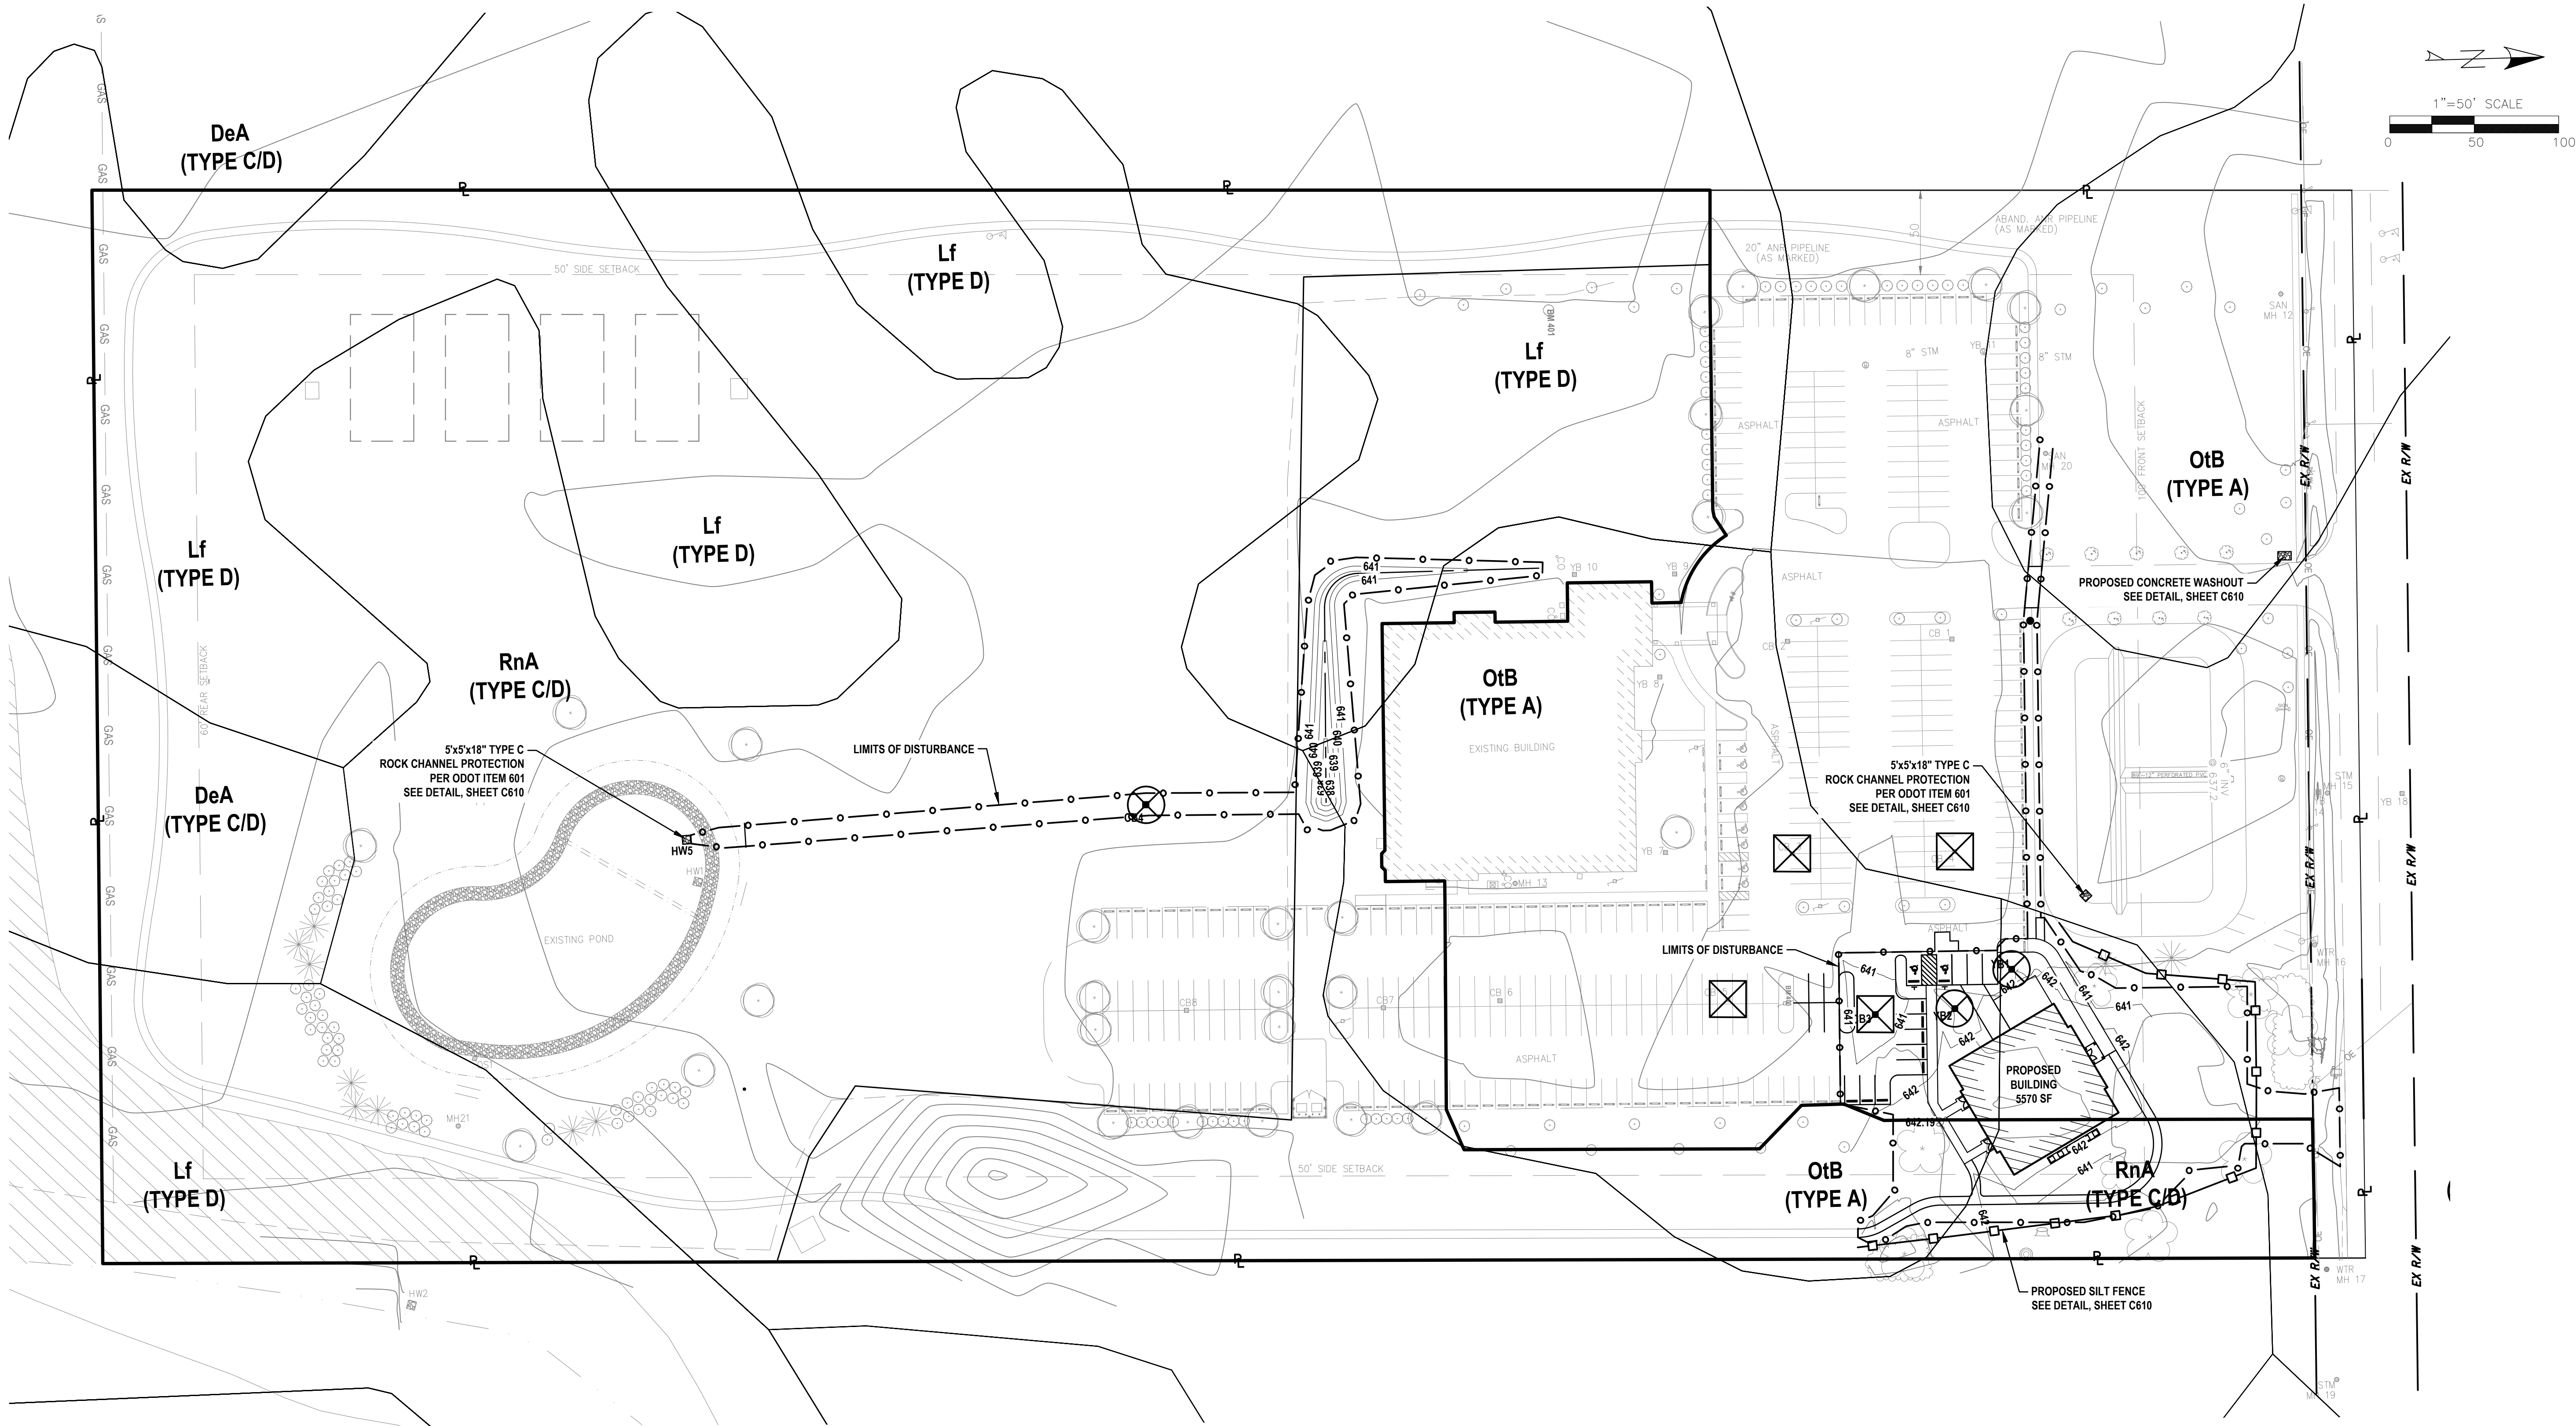

SOIL TYPE

SOILS WITHIN THE ENTIRE DISTURBED AREA CONSIST OF:

Lf	LENAWEE SILTY CLAY LOAM 0 TO 1 PERCENT SLOPES
DeA	DEL REY LOAM, SANDY SUBSTRATUM 0 TO 2 PERCENT SLOPES
RnA	RIMER LOAMY FINE SAND 0 TO 3 PERCENT SLOPES
OtB	OTTOKEE FINE SAND 0 TO 6 PERCENT SLOPES
Co	COLWOOD LOAM

CONSTRUCTION SEQUENCE FOR EROSION CONTROL

1. INSTALL SILT FENCE PER PLAN.
2. SITE DEMOLITION AND REMOVALS.
3. ROUGH GRADE SITE.
4. INSTALL BUILDING PAD.
5. INSTALL PROPOSED STORM SEWER STRUCTURES AND PIPING.
6. INSTALL CONCRETE WASH-OUT PIT PRIOR TO TAKING DELIVERY OF ANY CONCRETE.
7. INSTALL INLET PROTECTION ON CATCH BASINS AS THEY ARE INSTALLED.
8. GRADE SITE TO ACHIEVE PROPOSED GRADES.
9. CONSTRUCT PROPOSED SIDEWALKS.
10. COMPLETE PAVING OPERATIONS.
11. COMPLETE SITE CONSTRUCTION.

12. REMOVE CONCRETE WASH-OUT PIT UPON COMPLETION OF CONSTRUCTION AND SITE STABILIZATION.

PERFORM THE FOLLOWING UPON ESTABLISHMENT OF SITE VEGETATION

13. INSTALL LANDSCAPING.
14. REMOVE SILT FENCE, CONCRETE WASH-OUT PIT, AND DROP INLET PROTECTION.
15. CLEAN AND JET STORM SEWER SYSTEM, AS NEEDED.
16. IT IS THE RESPONSIBILITY OF THE CONTRACTOR TO ENSURE THAT ALL SOIL EROSION CONTROL MEASURES ARE INSTALLED AND MAINTAINED.

NOTE:


1. CONTRACTOR IS RESPONSIBLE FOR THE IMPLEMENTATION AND MAINTENANCE OF ALL EROSION CONTROL MEASURES.

LEGEND

- □ — □ — PROPOSED SILT FENCE
SEE DETAIL SHEET
- ○ — ○ — LIMITS OF DISTURBANCE
(1.12 ACRES)

RECIEIVING BODIES OF WATER

STORM WATER FROM THIS PORTION OF THE SITE
WILL BE DETAINED ONSITE IN THE PROPOSED WET
POND AND RELEASED INTO STONE DITCH.

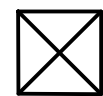

DANDY BAG INLET PROTECTION
IN PAVEMENT (SEE DETAIL SHEET)



SEDGACE INLET PROTECTION
OUTSIDE PAVEMENT (SEE DETAIL SHEET)



CONCRETE WASHOUT AREA
SEE DETAIL SHEET

PREPARED FOR:
REDEMPTION CHURCH
202 WEST MAIN STREET
MASON, OH 45440

**REDEMPTION CHURCH
SPECIAL FUNCTION
ACCESSORY BUILDING**
8605 SALISBURY ROAD
MONCLOVA, OH 43542

SWPPP PLAN

C600




TECHNICAL SKILL.
CREATIVE SPIRIT.

Mannik Smith GROUP
www.MannikSmithGroup.com

1800 INDIAN WOOD CIRCLE
MASON, OH 45404
TEL: 419.881.2222
FAX: 419.881.1595

PROJECT DATE: 06/11/2025
PROJECT NO.: 250745
DRAWN BY: JEC
CHECKED BY: MJM

NO.	DATE	BY	DESCRIPTION
1	10/30/2025	JEC	ISSUED FOR PERMITS
2	12/04/2025	JEC	MONCLOVA TOWNSHIP SUBMITTAL

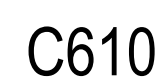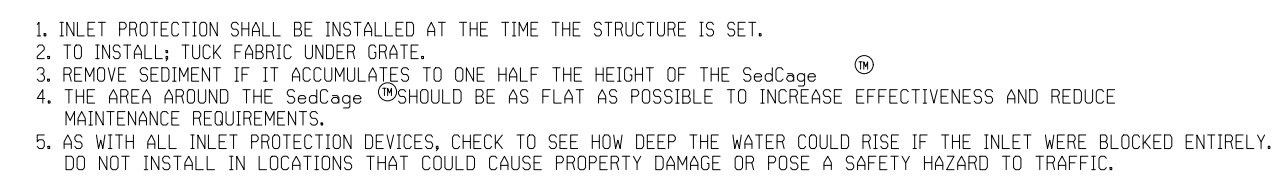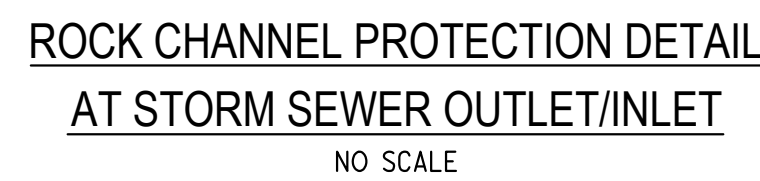

1. THE STORM WATER POLLUTION PREVENTION PLAN AND DETAILS SHALL BE AVAILABLE FOR INSPECTION ON SITE DURING WORKING HOURS.

2. CONTRACTOR SHALL MAINTAIN A LOG DOCUMENTING GRADING AND STABILIZATION ACTIVITIES AS WELL AS AMENDMENTS TO THE STORM WATER POLLUTION PLAN, WHICH OCCUR AFTER CONSTRUCTION ACTIVITIES COMMENCE.

3. MINIMIZE TRACKING OF SEDIMENTS BY VEHICLES BY UTILIZING THE CONSTRUCTION ENTRANCE AS THE ONLY ENTRANCE FOR VEHICLES. MAINTAIN THIS ENTRANCE WITH STONE AS NEEDED TO PREVENT DIRT AND MUD FROM TRACKING ONTO THE ROADWAY. REGULAR SWEEPING OF THE ROADWAY MAY BE NECESSARY TO ENSURE ROADWAY DOES NOT BUILD UP WITH SEDIMENTS.

4. THE OWNER OF RECORD MUST PROVIDE REGULAR INSPECTIONS BY A QUALIFIED PERSON AND MAINTENANCE FOR ALL EROSION AND SEDIMENT CONTROL PRACTICES. PERMANENT RECORDS OF ALL MAINTENANCE AND INSPECTIONS MUST BE KEPT THROUGHOUT THE CONSTRUCTION PERIOD. INSPECTION MUST BE MADE A MINIMUM OF ONCE EVERY SEVEN (7) DAYS AND IMMEDIATELY AFTER STORM EVENTS GREATER THAN 0.5 INCHES OF RAIN WITHIN A 24-HOUR PERIOD. THE NAME OF OWNER'S DESIGNATED INSPECTOR, MAJOR OBSERVATIONS, DATE OF INSPECTIONS AND CORRECTIVE MEASURES TAKEN MUST BE NOTED ON ALL INSPECTIONS. INSPECTION RECORDS SHALL BE KEPT FOR 3 YEARS AFTER TERMINATION OF CONSTRUCTION ACTIVITIES. NON SEDIMENT POND BMPs SHALL BE REPAIRED WITHIN 3 DAYS OF INSPECTION, AND SEDIMENT PONDs SHALL BE REPAIRED OR CLEANED OUT WITHIN 10 DAYS OF INSPECTION. BMPs MISSING OR NOT MEETING THE INTENDED FUNCTION SHALL BE REPLACED\INSTALLED WITHIN 10 DAYS OF INSPECTION. A COPY OF ALL EPA INSPECTION LOG SHEETS SHALL BE FORWARDED TO THE LCEO UPON COMPLETION OF EACH INSPECTION.

5. OTHER EROSION AND SEDIMENT CONTROL ITEMS MAY BE NECESSARY DUE TO ENVIRONMENTAL CONDITIONS AND MAY BE REQUIRED AT THE DISCRETION OF THE LOCAL AUTHORITIES.

6. SEDIMENT\STORMWATER PONDS AND EROSION AND SEDIMENT CONTROLS SHALL BE IMPLEMENTED AS THE FIRST STEP OF GRADING AND WITHIN 7 DAYS FROM THE START OF GRUBBING. UPON COMPLETION OF CONSTRUCTION OF PONDS, SEEDING AND MULCHING SHALL IMMEDIATELY FOLLOW TO AID IN THE STABILIZATION AND MINIMIZE EROSION AND SEDIMENT TRANSPORT OF THE SOIL BEFORE WATER LEAVES THE POND. ALL EROSION AND SEDIMENT CONTROLS SHALL CONTINUE TO FUNCTION UNTIL DISTURBED AREAS ARE RESTABILIZED. EROSION CONTROL MEASURES SHALL REMAIN IN PLACE UNTIL PERMANENT VEGETATION HAS BEEN ESTABLISHED.

7. NO SOLID OR LIQUID WASTE SHALL BE DISCHARGED INTO STORM WATER RUNOFF. (THIS INCLUDES WASHING OUT OF CEMENT TRUCKS.) DESIGNATED WASH PIT AREAS ARE SHOWN ON THE PLANS AND ARE PRESET FOR THIS PURPOSE AWAY FROM AREAS OF STORM WATER RUNOFF.

8. SITE STABILIZATION EITHER PERMANENT OR TEMPORARY MUST FOLLOW THE APPLICABLE FOLLOWING REQUIREMENTS:

8.1. PERMANENT STABILIZATION:

8.1.1. ANY AREA THAT WILL LIE DORMANT FOR ONE YEAR OR MORE MUST BE STABILIZED WITHIN 7 DAYS OF THE MOST RECENT DISTURBANCE.

8.1.2. ANY AREA WITHIN 50 FEET OF A WATERCOURSE, AND AT FINAL GRADE, MUST BE STABILIZED WITHIN 2 DAYS OF REACHING FINAL GRADE.

8.1.3. ANY AREA AT FINAL GRADE, MUST BE STABILIZED WITHIN 7 DAYS OF REACHING FINAL GRADE WITHIN THAT AREA.

8.2. TEMPORARY STABILIZATION:

8.2.1. ANY DISTURBED AREA WITHIN 50 FEET OF A WATERCOURSE AND NOT AT FINAL GRADE MUST BE STABILIZED WITHIN 2 DAYS OF THE MOST RECENT DISTURBANCE, IF THAT AREA WILL REMAIN IDLE FOR MORE THAN 14 DAYS.

8.2.2. FOR ALL CONSTRUCTION ACTIVITIES, ANY DISTURBED AREA, INCLUDING SOIL STOCKPILES, THAT WILL BE DORMANT FOR MORE THAN 14 DAYS BUT LESS THAN ONE YEAR, AND NOT WITHIN 50 FEET OF A WATERCOURSE MUST BE STABILIZED WITHIN 7 DAYS OF THE MOST RECENT DISTURBANCE WITHIN THE AREA.

8.2.3. DISTURBED AREAS THAT WILL BE IDLE OVER THE WINTER MUST BE STABILIZED BEFORE NOVEMBER 1.

8.3. WHERE VEGETATIVE STABILIZATION TECHNIQUES MAY CAUSE STRUCTURAL INSTABILITY OR ARE OTHERWISE UNOBTAINABLE, ALTERNATIVE STABILIZATION TECHNIQUES MUST BE EMPLOYED. THESE TECHNIQUES MAY INCLUDE MULCHING, EROSION MATTING, OR PLACEMENT OF STONE.

9. THE CONTRACTOR SHALL PHASE CONSTRUCTION ACTIVITIES AS MUCH AS POSSIBLE TO MINIMIZE THE AMOUNT OF LAND DISTURBANCE AT ONE TIME.

10. THE CONTRACTOR SHALL LIMIT THE SURFACE AREA OF ERODIBLE EARTH MATERIAL EXPOSED BY EXCAVATION, BORROW, AND FILL OPERATIONS AND PROVIDE IMMEDIATE PERMANENT OR TEMPORARY CONTROL MEASURES TO PREVENT CONTAMINATION OF ADJACENT STREAMS OR OTHER WATER COURSES, LAKES, PONDS, OR OTHER AREAS OF WATER IMPOUNDMENT.

11. THIS WORK SHALL CONSIST OF TEMPORARY CONTROL MEASURES AS DETAILED IN THE PLANS OR ORDERED BY THE ENGINEER DURING THE LIFE OF THE CONTRACT TO CONTROL SOIL EROSION AND SEDIMENTATION THROUGH USE OF BEST MANAGEMENT PRACTICES AS DETAILED IN THE OHIO RAINWATER AND LAND DEVELOPMENT MANUAL.

12. TEMPORARY EROSION AND SEDIMENT CONTROL ITEMS, THE LOCATION AND SIZE OF WHICH ARE DETAILED IN THE PLANS, SHALL BE INSTALLED BY THE CONTRACTOR UPON COMMENCEMENT OF ANY CLEARING OR EARTHWORK OPERATIONS. TEMPORARY CONTROL MEASURES WILL BE USED WHEN AND AS DIRECTED BY THE ENGINEER TO CORRECT CONDITIONS THAT DEVELOP DURING CONSTRUCTION THAT WERE NOT FORESEEN DURING THE DESIGN STAGE, THAT ARE NEEDED PRIOR TO INSTALLATION OF PERMANENT CONTROL FEATURES, OR THAT ARE NEEDED TEMPORARILY TO CONTROL EROSION THAT DEVELOPS DURING NORMAL CONSTRUCTION PRACTICES.

13. EXISTING VEGETATIVE GROWTH SHALL REMAIN UNDISTURBED AS LONG AS POSSIBLE. THE CONTRACTOR SHALL SEED AND MULCH ALL AREAS DISTURBED.

14. TEMPORARY EROSION CONTROL FEATURES SHALL BE ACCEPTABLY MAINTAINED AND SHALL SUBSEQUENTLY BE REMOVED OR REPLACED WHEN DIRECTED BY THE ENGINEER. TEMPORARY AND PERMANENT EROSION CONTROL FEATURES SHALL BE CHECKED AFTER EACH MEASURABLE RAINFALL AND RE-ESTABLISHED AS NECESSARY. REMOVED MATERIALS SHALL BECOME THE PROPERTY OF THE CONTRACTOR AND SHALL BE DISPOSED OF OFF THE SITE.

15. CONTRACTOR IS TO PROVIDE SPECIFIC LOCATIONS FOR THE PROPER CROSSING OF DIVERSION SWALES WITH VEHICLES AND EQUIPMENT. AT THESE LOCATIONS THE DIVERSION SWALES SHALL BE PROTECTED FROM INCURRING DAMAGE FROM THE VEHICLES AND EQUIPMENT. IF ANY DAMAGE IS TO OCCUR THE CONTRACTOR IS RESPONSIBLE FOR REPAIRING SAID DAMAGE IMMEDIATELY, PRIOR TO CONTINUATION OF WORK ON SITE.

16. IN THE EVENT THAT TEMPORARY EROSION AND SEDIMENT CONTROL MEASURES ARE REQUIRED DUE TO THE CONTRACTOR'S NEGLIGENCE, CARELESSNESS, OR FAILURE TO INSTALL PERMANENT CONTROLS AS A PART OF THE WORK AS SCHEDULED, AND ARE ORDERED BY THE ENGINEER, SUCH TEMPORARY WORK SHALL BE PERFORMED BY THE CONTRACTOR AT HIS EXPENSE.

17. TEMPORARY SEEDING SPECIFICATIONS:

SEEDING DATES	SEEDING TYPES	APPLICATION RATE (POUNDS PER 1000 SQ. FT.)
MARCH 1 - AUGUST 15	OATS OR PERENNIAL RYE GRASS	3*
	TALL FESCUE	1*
AUGUST 16 - NOVEMBER 1	RYE,WHEAT OR PERENNIAL RYE GRASS	3*
	TALL FESCUE	1*
AFTER NOVEMBER 1	STRAW OR HAY MULCH	2-3 BALES
SEED BED PREPARATION	LIME 10-10-10 OR 12-12-12 FERTILIZER	100*

THE CONTRACTOR SHALL MAINTAIN ALL SEEDED, MULCHED AREAS UNTIL FINAL INSPECTION. MAINTENANCE SHALL ALSO INCLUDE REPAIRING ANY AREAS DAMAGED FOLLOWING THE SEEDING OR MULCHING OPERATION DUE TO WIND, WATER, FIRE, OR OTHER CAUSES. SUCH DAMAGED AREAS SHALL BE REPAIRED TO RE-ESTABLISH THE CONDITION OF THE GRADE OF THE AREA PRIOR TO SEEDING AND SHALL THEN BE RE-FERTILIZED RE-SEEDED, RE-MULCHED AS DIRECTED BY THE PROJECT ENGINEER.

ALL DISTURBED AREAS NOT DESIGNATED TO RECEIVE A FINISHED SURFACE SHALL BE SEEDED WITH ODOT CLASS 1 MIXTURE, MULCHED AND FERTILIZED PER ODOT SPECIFICATION 659. ALL LAWN AND PLANTER AREAS SHALL RECEIVE A MINIMUM OF 4" TOPSOIL. FINAL GRADES AS INDICATED ON THE DRAWINGS.

IMMEDIATELY AFTER SEEDING, MULCH ALL SEEDED AREAS WITH UNWEATHERED SMALL GRAIN STRAW AND SPREAD UNIFORMLY AT THE RATE OF 1 1/2 TO 2 TONS PER ACRE OR 100 POUNDS (2 TO 3 BALES) PER 1,000 SQUARE FEET. THIS MULCH SHOULD BE ANCHORED WITH A DISC-TYPE ANCHORING TOOL OR OTHER MEANS.

18. INSTALL SILT FENCE OR COMBINATION BARRIERS AT LOCATIONS SO INDICATED ON THE STORMWATER POLLUTION PREVENTION PLAN (SEE DETAIL). PROVIDE FOR TEMPORARY SEDIMENT CONTROL AT STOCKPILES (TEMPORARY AND EXCESS) BY PLACING SILT FENCE AROUND STOCKPILES.

19. INLET PROTECTION TO BE PLACED AROUND ALL YARD DRAINS TO MINIMIZE SILTING OF PIPE AND TRANSPORT OF SILT (SEE DETAIL).

20. INSTALL DANDY BAGS ON INLETS IN PAVEMENT.

21. INSTALL TEMPORARY AGGREGATE PAD AT POINT OF INGRESS AND EGRESS FROM PROJECT TO PREVENT VEHICULAR TRACKING OFF-SITE (SEE DETAIL). THE PAD SHALL BE CLEANED AND REPLENISHED, AS NECESSARY, DURING THE CONSTRUCTION PERIOD.

22. TOPSOIL STOCKPILES SHALL RECEIVE TEMPORARY SEEDING AND MULCHING AS SOON AS STOCKPILING OPERATIONS ARE COMPLETED OR A SILT FENCE SHALL BE INSTALLED ALONG AND 20 FEET FROM THE TOE OF THE STOCKPILE. TOPSOIL SHALL BE REPLACED AS QUICKLY AS CONSTRUCTION PERMITS.

23. ADDITIONAL EROSION CONTROLS MAY BE MANDATED BY THOSE AGENCIES HAVING JURISDICTION.

24. ROUTINE INSPECTION WILL BE CONDUCTED ON ALL EROSION CONTROL PRACTICES FOR THIS PROJECT. THE CONTRACTOR WILL BE RESPONSIBLE FOR CORRECTING ALL DEFICIENCIES REVEALED BY THE INSPECTIONS.

25. ALL EROSION CONTROL PRACTICES SHALL MEET THE STANDARDS AND SPECIFICATIONS OF THE OHIO EPA GENERAL CONSTRUCTION PERMIT REQUIREMENTS.

26. PRIOR TO BEGINING CONSTRUCTION, THIS SITE WILL WILL OBTAIN COVERAGE UNDER OHIO EPA GENERAL PERMIT OHC000006 FOR STORM WATER POLLUTION ASSOCIATED WITH CONSTRUCTION.

27. THE GENERAL LOCATION OF THE STAGING AREA IS NOT SHOWN. THE STAGING AREA SHALL BE ESTABLISHED EITHER ON EXISTING PAVEMENT OR ON 12" OF GRANULAR AGGREGATE BASE. IF AN AGGREGATE BASE COURSE IS USED, THEN THE CONTRACTOR IS RESPONSIBLE TO MAINTAIN THE STONE SUCH THAT IT IS REPLENISHED WHEN THE DEPTH IS LESS THAN 6" OR REMOVED AND REPLACED IF THE STONE BECOMES LADEN WITH MUD.

28. A SPILL PREVENTION CONTROL AND COUNTERMEASURES (SPCC) PLAN MUST BE DEVELOPED FOR SITES WITH ONE ABOVE GROUND STORAGE TANK (AST) OF 660 GALLONS OR MORE, TOTAL ABOVE GROUND TANK STORAGE OF 1330 GALLONS, OR BELOW GROUND STORAGE OF 42,000 GALLONS OF FUEL.

WASTE DISPOSAL

29. THE CONTRACTOR IS RESPONSIBLE TO PROVIDE A MINIMUM OF ONE SOLID WASTE DISPOSAL RECEPTACLE, AND HAVE THIS RECEPTACLE EMPTIED BY A CONTRACT TRASH DISPOSAL SERVICE AND HAULED AWAY FROM THE SITE AS NECESSARY. NO SOLID MATERIALS, INCLUDING BUILDING MATERIALS, PAINTS, STAINS, GASOLINE, DIESEL FUEL, USED MOTOR OIL, HYDRAULIC FLUID, ANTIFREEZE, CEMENT, CURING COMPOUND AND OTHER SUCH TOXIC OR HAZARDOUS WASTE, MUST BE COLLECTED AND PLACED IN THESE RECEPTACLES. THE LOCATION IS TO BE DETERMINED IN THE FIELD. ALL CONTAINERS MUST BE COVERED AND LEAK-PROOF. ALL WASTE DISPOSAL, INCLUDING OPEN BURNING, SANITARY WASTES, AND CONSTRUCTION AND DEMOLITION DEBRIS SHALL COMPLY WITH APPLICABLE STATE OR LOCAL WASTE DISPOSAL REQUIREMENTS.

SPILL REQUIREMENTS

30. SHOULD AN ACCIDENTAL SPILL OCCUR, IMMEDIATE ACTION WILL BE UNDERTAKEN BY THE GENERAL CONTRACTOR TO CONTAIN AND REMOVE THE SPILLED MATERIAL IMMEDIATELY AND BE DISPOSED OF BY THE CONTRACTOR IN THE MANNER SPECIFIED BY LOCAL, STATE, AND FEDERAL REGULATIONS AND BY THE MANUFACTURER OF SUCH PRODUCTS, AS SOON AS POSSIBLE. ALL SPILLS >25 GALLONS SHALL BE REPORTED TO THE APPROPRIATE STATE AND LOCAL AGENCIES, THIS SHALL INCLUDE THE OHIO EPA AT 800-282-9378. THE LOCAL FIRE DEPARTMENT, THE NATIONAL RESPONSE CENTER AT 800-424-8802, US COAST GUARD 440-288-1206 (IF APPLICABLE) OR THE APPROPRIATE LCEO OR LUCAS COUNTY DEPARTMENTS.

31. ALL CONTAMINATED SOILS MUST BE TREATED AND/OR DISPOSED IN OHIO EPA APPROVED SOLID WASTE MANAGEMENT FACILITIES OR HAZARDOUS WASTE TREATMENT, STORAGE OR DISPOSAL FACILITIES (TSDFs). NON-SEDIMENT POLLUTION CONTROLS. CONTRACTOR SHALL CONSTRUCT BERMS, TRENCHES OR PITS TO COLLECT CONTAMINATED RUNOFF OR COVER CONTAMINATION WITH TARPS OR OTHER METHODS TO PREVENT ANY CONTACT WITH CONTAMINATED SOILS.

32. THE CONTRACTOR IS RESPONSIBLE FOR ALL NON-SEDIMENT POLLUTION CONTROLS AT THIS SITE, WHICH PROHIBIT NON-SEDIMENT POLLUTANTS FROM DISCHARGING INTO RUNOFF OR INTO THE GROUND AND MUST DISPOSE OF THEM IN A PROPER MANNER IN ACCORDANCE WITH LOCAL, STATE AND FEDERAL REGULATORY AUTHORITIES. IT IS PROHIBITED TO BURN, BURY, OR POUR OUT ONTO THE GROUND, DITCH OR INTO A STORM SEWER. SOLVENTS, PAINTS, STAINS, GASOLINE, DIESEL FUEL, USED MOTOR OIL, HYDRAULIC FLUID, ANTIFREEZE, CEMENT, CURING COMPOUND AND OTHER SUCH TOXIC OR HAZARDOUS WASTE. STORAGE TANKS SHALL BE LOCATED IN DIKED AREAS AWAY FROM DRAINAGE CHANNELS AND THE DIKED AREA SHOULD HOLD A VOLUME OF 110% OF THE LARGEST TRUCK OR TANK. SHOULD THE CONTRACTOR FAIL TO PREVENT NON-SEDIMENT POLLUTION AT THIS SITE, HE MUST IMMEDIATELY REMEDIATE THE SITE TO LOCAL, STATE AND FEDERAL REGULATORY AUTHORITIES APPROVAL AT HIS OWN EXPENSE.

33. CONTRACTOR MAY NOT USE OIL AS A DUST SUPPRESSANT.

CONSTRUCTION FILL, DEMOLITION DEBRIS & CHEMICAL COMPOUNDS

34. THE CONTRACTOR IS RESPONSIBLE TO PREVENT DISCHARGE OF WASTE CONCRETE AND/OR WASH WATER FROM CONCRETE TRUCKS FROM MIXING WITH RUN-OFF AND LEAVING THE SITE. THE CONTRACTOR SHALL SIZE THE CONCRETE WASHOUT PIT TO HANDLE HIS PROPOSED CONCRETE OPERATIONS AND SHALL MAINTAIN THE PIT SUCH THAT ALL CONCRETE TRUCKS CAN USE IT TO WASHOUT. ALL CURED RESIDUE FROM THE PIT SHALL BE DISPOSED OF IN ACCORDANCE WITH LOCAL, STATE AND FEDERAL REGULATIONS. A GENERAL LOCATION FOR THE WASHOUT PIT IS SHOWN ON THE PLAN AND MAY BE MOVED TO BETTER FIT THE CONTRACTOR'S METHODS.

35. ALL CONSTRUCTION AND DEMOLITION DEBRIS (C&DD) WASTE WILL BE DISPOSED OF IN AN OHIO EPA APPROVED C&DD LANDFILL AS REQUIRED BY OHIO REVISED CODE(ORC)3714. MATERIALS WHICH CONTAIN ASBESTOS MUST COMPLY WITH AIR POLLUTION REGULATIONS (SEE OHIO ADMINISTRATIVE CODE (OAC) 3745-20).

36. SOIL EROSION AND SEDIMENTATION BEST MANAGEMENT PRACTICE (BMP) MEASURES WILL BE INSTALLED PRIOR TO START OF ANY CONSTRUCTION AND WILL BE MAINTAINED AT ALL TIMES UNTIL CONSTRUCTION HAS BEEN COMPLETED, INCLUDING ALL GRASS BEING WELL ESTABLISHED AND/OR PERMANENT EROSION AND SEDIMENTATION BMP MEASURES ARE IN PLACE. ALL BMP MEASURES WILL BE INSTALLED TO THE SATISFACTION OF THE LCEO. THE LCEO MAY REQUIRE WORK TO BE STOPPED AND THE STORM DRAINAGE OUTLET TO BE PLUGGED, IF CONDITIONS BECOME UNSATISFACTORY.

37. CONTRACTOR SHALL NOTIFY LCEO THREE (3) DAYS PRIOR TO STARTING CONSTRUCTION FOR PURPOSE OF MONITORING EROSION AND BMP MEASURES.

38. CONTRACTOR IS TO DESIGNATE A SITE DUMP\WASH AREA PRIOR TO STARTING CONSTRUCTION FOR SUCH PURPOSES AS WASHING OUT CONCRETE TRUCKS AND DUMPING NON-HAZARDOUS WASTE MATERIALS, SUBJECT TO THE SUPERVISION OF THE LCEO. DUMPING OR DISCHARGE OF ANY WASTE MATERIALS TO ANY PUBLIC SEWERS OR DITCHES IS PROHIBITED. HAZARDOUS WASTES ARE TO BE REMOVED OFF SITE AND PROPERLY DISPOSED OF CONSISTENT WITH ALL FEDERAL, STATE AND LOCAL REGULATIONS.

39. ANY PARTY (TYPICALLY THE GENERAL CONTRACTOR) WHO HAS DAY-TO-DAY OPERATIONAL CONTROL OF ACTIVITIES AT THIS PROJECT, WHICH ARE NECESSARY TO ENSURE COMPLIANCE WITH THE SWP3 FOR THE SITE OR OTHER CONDITIONS AS SET FORTH IN THE PERMIT, MUST FILE A CO-PERMITTEE NOI WITH THE OHIO EPA. THIS IS THE SOLE RESPONSIBILITY OF THE CO-PERMITTEE AND SHALL BE DONE 21 DAYS BEFORE GROUND IS BROKEN.

Storm Water Pollution Prevention Plan (SWPPP)

Project Narrative:

The existing site is located at 8605 Salisbury Road in Monclova Township. The existing parcel is currently an existing church campus. Existing drainage is split with the front part of the site draining north to Salisbury Road, and the rear portion of the site drains South-East to Stone Ditch.

The proposed site is part of a 18.97 acre parcel that houses the existing Redemption Church. The front 7.36 acre drainage area is existing and drains north to an existing detention pond in the front of the property. The proposed project will reconfigure that drainage area to include 6.57 acres. The remaining area will be diverted to the wet pond in the rear of the property. Proposed construction consists of a new 5570 sf accessory building, and supporting site infrastructure. The proposed use of the new building is for special functions that will not take place at the same time as Sunday morning services. The limits of disturbance for the proposed project is 1.12 acres. The existing ponds on site have capacity for the entire site including the proposed improvements without modification.

The proposed impervious area for the front pond will be 136,452 sf or 47.3% of the drainage area. A runoff coefficient for the existing site of 0.16 was used for calculations. A runoff coefficient of 0.54 was calculated for the proposed conditions. Proposed drainage from the site will be piped and then detained and treated in the existing dry pond. Storm water will continue to outlet from the existing pond to the Salisbury Road right of way storm.

The proposed impervious area for the rear pond will be 68,408 sf or 14.4% of the drainage area. A runoff coefficient for the existing site of 0.62 was used for calculations. A runoff coefficient of 0.66 was calculated for the proposed conditions. Proposed drainage from the site will be piped and then detained and treated in the existing wet pond. Storm water will continue to outlet from the existing pond to stone ditch at the rear of the site.

Best Management practices are accomplished by:

- Catch Basins have 2' sumps.
- Water Quality will be treated through a Forebay in the ponds.
- Inlet Filters will be placed around all catch basins within and in the immediate vicinity of the construction limits.
- Silt fence is provided around the site to treat storm water runoff.

The project is expected to begin in fall of 2025 and construction is expected to last 6 months.


Storm Water Inspection shall occur on a weekly basis and within 24 hours of a 1/2" rain or more by qualified inspection personnel. Inspector shall conduct and log inspections using an EPA Standard Inspection Log Sheet. Inspection sheets are available on the EPA website at:

<https://www.epa.gov/npdes/construction-general-permit-resources-tools-and-templates#inspection>

The SWP3 plans and details shall be available for inspection on site during working hours.

DESCRIPTION	ISSUED FOR PERMITS	BY	DATE	NO.	1800 INDIAN WOOD CIRCLE MASON, OH 45040 TEL: 419.881.1222 FAX: 419.881.1595	PROJECT DATE: 06/11/2025 PROJECT NO: 250745 DRAWN BY: JEC CHECKED BY: MJM
JEC	JEC	JEC	12/04/2025	2		
MONCLOVA TOWNSHIP	SUBMITTAL					
TECHNICAL SKILL- CREATIVE SPIRIT.						
PREPARED FOR:	REDEMPTION CHURCH					
	202 WEST MAIN STREET MASON, OH 45040					
REDEMPTION CHURCH SPECIAL FUNCTION ACCESSORY BUILDING						
	8605 SALISBURY ROAD MONCLOVA, OH 43042					
SWPPP NOTES						
C620						

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PLANT LIST

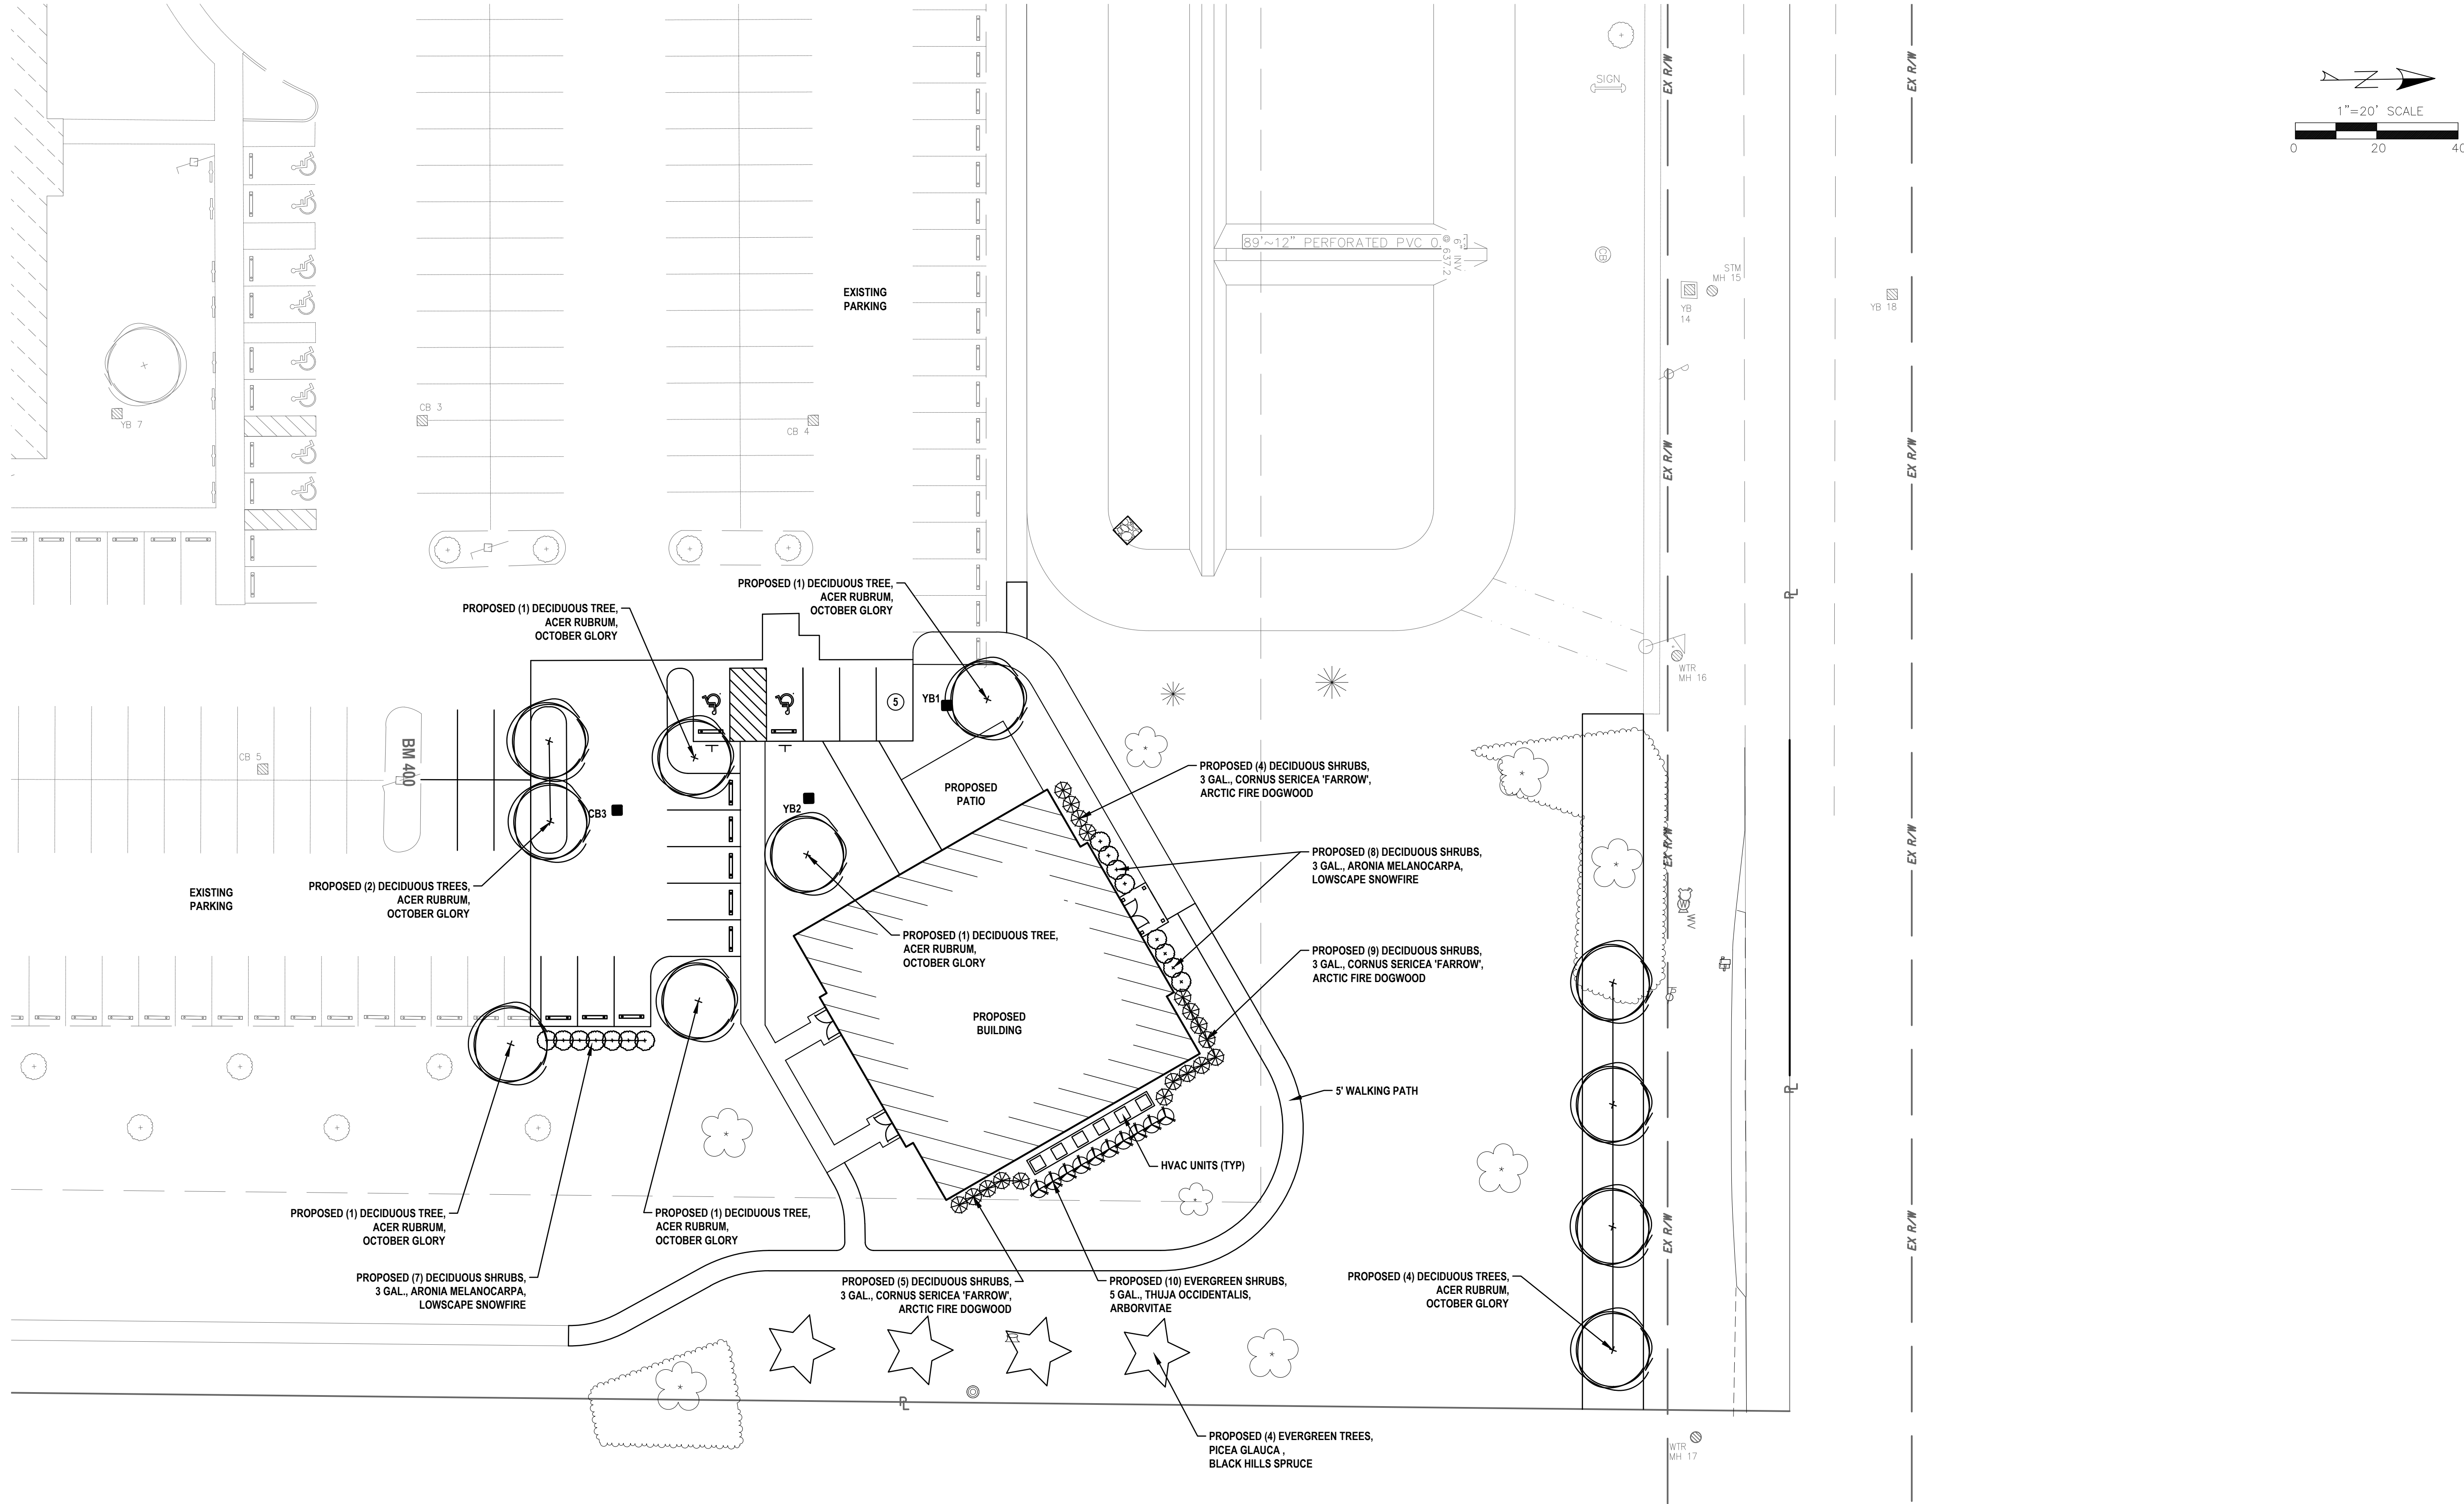Key			Qty. TOTAL	Botanical Name	Common Name	Minimum Size	Spacing	Mature Height	Spread
				TREES					
ACX	11	11		Acer rubrum	October Glory	3" caliper	see plan	35'	40'
PG	4	4		Picea glauca	Black Hills Spruce	6' min.	see plan	20'-60'	20-25'
				SHRUBS					
AMC	15	15		Aronia melanocarpa	Lowscape Snowfire	3 gal.	4' o.c.	6'	6'
AV	10	10		Thuja occidentalis	Arborvitae	5 gallon	4' o.c.	10'	8'
CF	18	18		Cornus sericea 'Farrow'	Arctic Fire Dogwood	3 gal	4' o.c.	3-4'	3-4'

REDEMPTION CHURCH
SPECIAL FUNCTION
ACCESSORY BUILDING
8605 SALISBURY ROAD
MONCLOVA, OH 43942

PREPARED FOR:
REDEMPTION CHURCH
202 WEST MAIN STREET
MASON, OH 45040

TECHNICAL SKILL.
CREATIVE SPIRIT.
Mannik Smith Group
www.MannikSmithGroup.com

ENLARGED LANDSCAPE PLAN

L100

NO.	DATE	BY	DESCRIPTION
1	10/30/2025	JEC	ISSUED FOR PERMITS
2	12/24/2025	JEC	MONCLOVA TOWNSHIP SUBMITTAL

1800 INDIAN WOOD CIRCLE
MASON, OH 45040
TEL: 419.881.2222
FAX: 419.881.1595

PROJECT DATE: 06/11/2025
PROJECT NO.: 250745
DRAWN BY: JEC
CHECKED BY: MJM

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LANDSCAPING PLANTING NOTES:

THE WORK CONSISTS OF PROVIDING ALL NECESSARY MATERIALS, LABOR, EQUIPMENT, TOOLS & SUPERVISION REQUIRED TO COMPLETE THE WORK AS SHOWN ON THE DRAWINGS. THE CONTRACTOR SHALL BE RESPONSIBLE FOR CONTACTING & COORDINATING WITH ALL PERTINENT UTILITY COMPANIES 3 WORKING DAYS IN ADVANCE OF ANY DIGGING TO FAMILIARIZE THEMSELVES WITH ALL UNDERGROUND UTILITIES, PIPES & STRUCTURES. THE CONTRACTOR SHALL ASSUME SOLE RESPONSIBILITY FOR ANY COST INCURRED DUE TO DAMAGE OF ANY UTILITIES.

THE CONTRACTOR SHALL NOT WILLFULLY PROCEED WITH THE CONSTRUCTION AS DESIGNED WHEN IT IS OBVIOUS THAT OBSTRUCTIONS &OR GRADE DIFFERENCES EXIST. SUCH CONDITIONS SHALL BE IMMEDIATELY BROUGHT TO THE ATTENTION OF THE OWNER'S REPRESENTATIVE. THE CONTRACTOR SHALL ASSUME FULL RESPONSIBILITY FOR ALL NECESSARY REVISIONS DUE TO FAILURE TO GIVE NOTIFICATION. DISCREPANCIES BETWEEN DIMENSIONED LAYOUT & ACTUAL FIELD CONDITIONS SHALL BE IMMEDIATELY BROUGHT TO THE ATTENTION OF THE OWNER'S REPRESENTATIVE. THE CONTRACTOR SHALL ASSUME FULL RESPONSIBILITY FOR ALL NECESSARY REVISIONS DUE TO FAILURE TO GIVE SUCH NOTIFICATION. THE CONTRACTOR SHALL BE RESPONSIBLE FOR COORDINATION WITH SUBCONTRACTORS AS REQUIRED TO ACCOMPLISH CONSTRUCTION INSTALLATION OPERATIONS. THE CONTRACTOR SHALL PROVIDE & MAINTAIN POSITIVE SURFACE DRAINAGE. THE CONTRACTOR SHALL BE RESPONSIBLE FOR EXISTING MATERIALS DAMAGED DURING CONSTRUCTION.

WARRANTY

THE CONTRACTOR SHALL PROVIDE A ONE-YEAR WARRANTY ON ALL PLANTS, SEEDED AREAS, & VEGETATION INSTALLED WITH THIS PROJECT. ANY TREES, SHRUBS, OR OTHER VEGETATION PLANTED AS PART OF THIS PROJECT THAT DO NOT SURVIVE ONE YEAR FROM PLANTING SHALL BE REPLACED AT THE EXPENSE OF THE CONTRACTOR.

TOPSOIL

PROVIDE A MINIMUM OF 4" OF SCREENED TOPSOIL IN ALL AREAS TO BE SEEDDED. TOPSOIL SHALL BE FERTILE, FRIABLE, NATURAL TOPSOIL OF LOAMY CHARACTER. PLANT MIX & TOPSOIL SHALL BE CLEAN OF STONES 1" OR LARGER IN ANY DIMENSION, CLAY CLUMPS, PLANTS, ROOTS, STICKS & OTHER FOREIGN MATERIALS HARMFUL TO PLANT GROWTH. TOPSOIL & PLANT MIX SHALL SUPPORT PLANT GROWTH. ORGANIC CONTENT SHALL BE BETWEEN 4% - 10%. CLAY CONTENT SHALL BE BETWEEN 5%-15%. PH SHALL BE BETWEEN 5.0 & 8.0. FINE GRADE ALL AREAS TO RECEIVE TOPSOIL.

PLANTING AREAS

AREAS SHALL BE FREE OF WEEDS PRIOR TO INITIATION OF PLANTING & SEEDING. IF WEEDS EXIST, SPRAY SITE WITH A NON-SELECTIVE HERBICIDE AS RECOMMENDED & APPROVED BY A LICENSED LANDSCAPE HERBICIDE APPLICATOR. LEAVE PLANTS INTACT FOR AT LEAST 15 DAYS. REPEAT PROCEDURE IF NEW WEEDS APPEAR. GRUB OFF WEEDS TO THE SURFACE. APPLY PLANT MIX TO A DEPTH OF 12" IN ALL SHRUB, PERENNIAL & ANNUAL PLANTING BEDS &6" IN ORNAMENTAL GRASS BEDS. PLANT MIX SHALL CONSIST OF 1/3 TOPSOIL, 1/3 SHARP SAND & 1/3 CERTIFIED COMPOST.

PLANT MATERIALS

REFER TO THE DRAWINGS &PLANTING DETAILS FOR PLANTING REQUIREMENTS, MATERIALS & EXECUTION. IF THERE IS A DISCREPANCY BETWEEN THE DRAWINGS & THE PLANT LIST, THE DRAWINGS SHALL GOVERN. PLANTS DESIGNATED 'B&B' SHALL BE BALLED & BURLAPPED WITH FIRM ROOT BALLS. ALL TREES SHALL HAVE CLAY LOAM OR CLAY ROOT BALLS. TREES WITH SAND ROOT BALLS SHALL NOT BE ACCEPTED.


AN IRRIGATION SYSTEM IS NOT PROPOSED FOR THIS PROJECT. PLANTS SHALL BE NATIVE SPECIES AND/OR DROUGHT RESISTANT AND TREES SHALL BE WATERED ON A WEEKLY BASIS FOR THE FIRST 2 YEARS AFTER PLANTING. WATER BAGS MAY BE UTILIZED TO ASSIST WITH WATERING, HOWEVER THEY SHOULD BE FILLED ON A WEEKLY BASIS.

BARK MULCH

MULCH TO BE DOUBLE SHREDDED NATIVE HARDWOOD BARK MULCH, NOT LARGER THAN 1" IN LENGTH, FREE OF WOOD CHIPS & SAWDUST. AFTER PLANTING, PLACE 3" DEPTH OF SINGLE SHREDDED HARDWOOD BARK MULCH AROUND ALL TREES & SHRUBS.

TURF SEEDING/RESTORATION

REFER TO SWPPP PLANS FOR SOIL STABILIZATION. ALL DISTURBED AREAS SHALL BE RESTORED TO EQUAL OR BETTER THAN THE PREVIOUS CONDITIONS. THE DISTURBED AREA SHALL BE GRADED SMOOTH & UNIFORM TO PROVIDE A POSITIVE FINISHED GRADE FOR DRAINAGE RUNOFF & SEEDING. SEEDDED AREAS SHALL HAVE A MULCH COVER SPREAD & A TACKIFIED ANCHOR APPLIED ON SAME DAY AS SEEDING OCCURS.

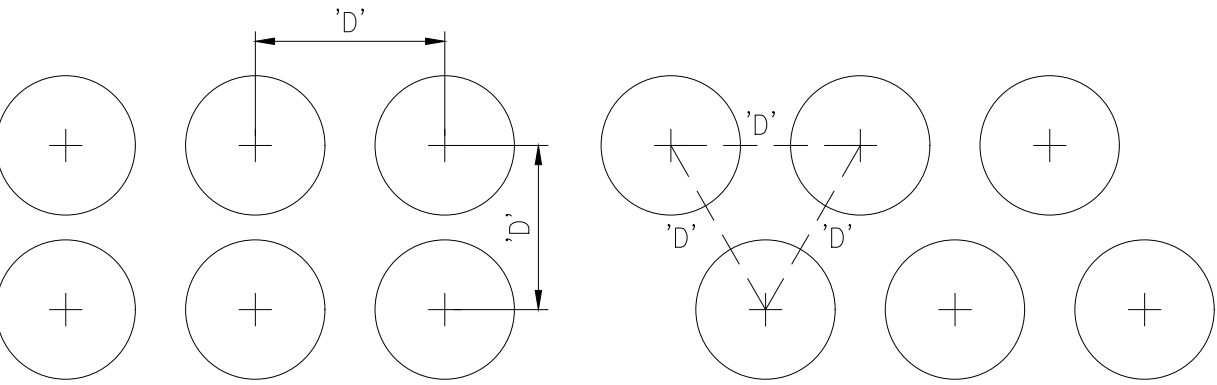

'D' = PLANT SPACING AS INDICATED IN PLANT LIST

SPACING 'D'	PLANTS REQUIRED PER SQ. FT.
6" o.c.	4.61
12" o.c.	1.15
24" o.c.	.28
36" o.c.	.12
48" o.c.	.07


CONTRACTOR SHALL USE THIS SPACING CHART TO DETERMINE TOTAL QUANTITIES OF SHRUBS AND GROUNDCOVERS. CONTRACTOR SHALL ROUND TOTAL UP TO NEAREST WHOLE PLANT. THE CONTRACTOR SHALL BE RESPONSIBLE FOR PROVIDING ALL PLANTINGS NECESSARY TO FILL ALL PLANTING AREAS SHOWN ON THE PLANS BASED UPON PLANT SPACES PROVIDED BY THE SPACING DIAGRAM AND CHART. ANY QUANTITIES GIVEN BY THE OWNER OR LANDSCAPE DESIGNER, OR DETERMINED BY THE CONTRACTOR SHALL BE FOR REFERENCE ONLY. THE CONTRACTOR SHALL BE RESPONSIBLE FOR ALL COSTS ASSOCIATED WITH UNDERESTIMATES.

SHRUB AND GROUNDCOVER PLANT SPACING DETAIL

NO SCALE

NOTES:


STAKES TO EXTEND 18" INTO UNDISTURBED SOIL.
SET STAKES VERTICAL AND AT EQUAL HEIGHT.
REFER TO SPECIFICATIONS FOR ADDITIONAL INFORMATION.
STAKE TREES UNDER 3" CALIPER - GUY TREES 3" CALIPER & OVER.

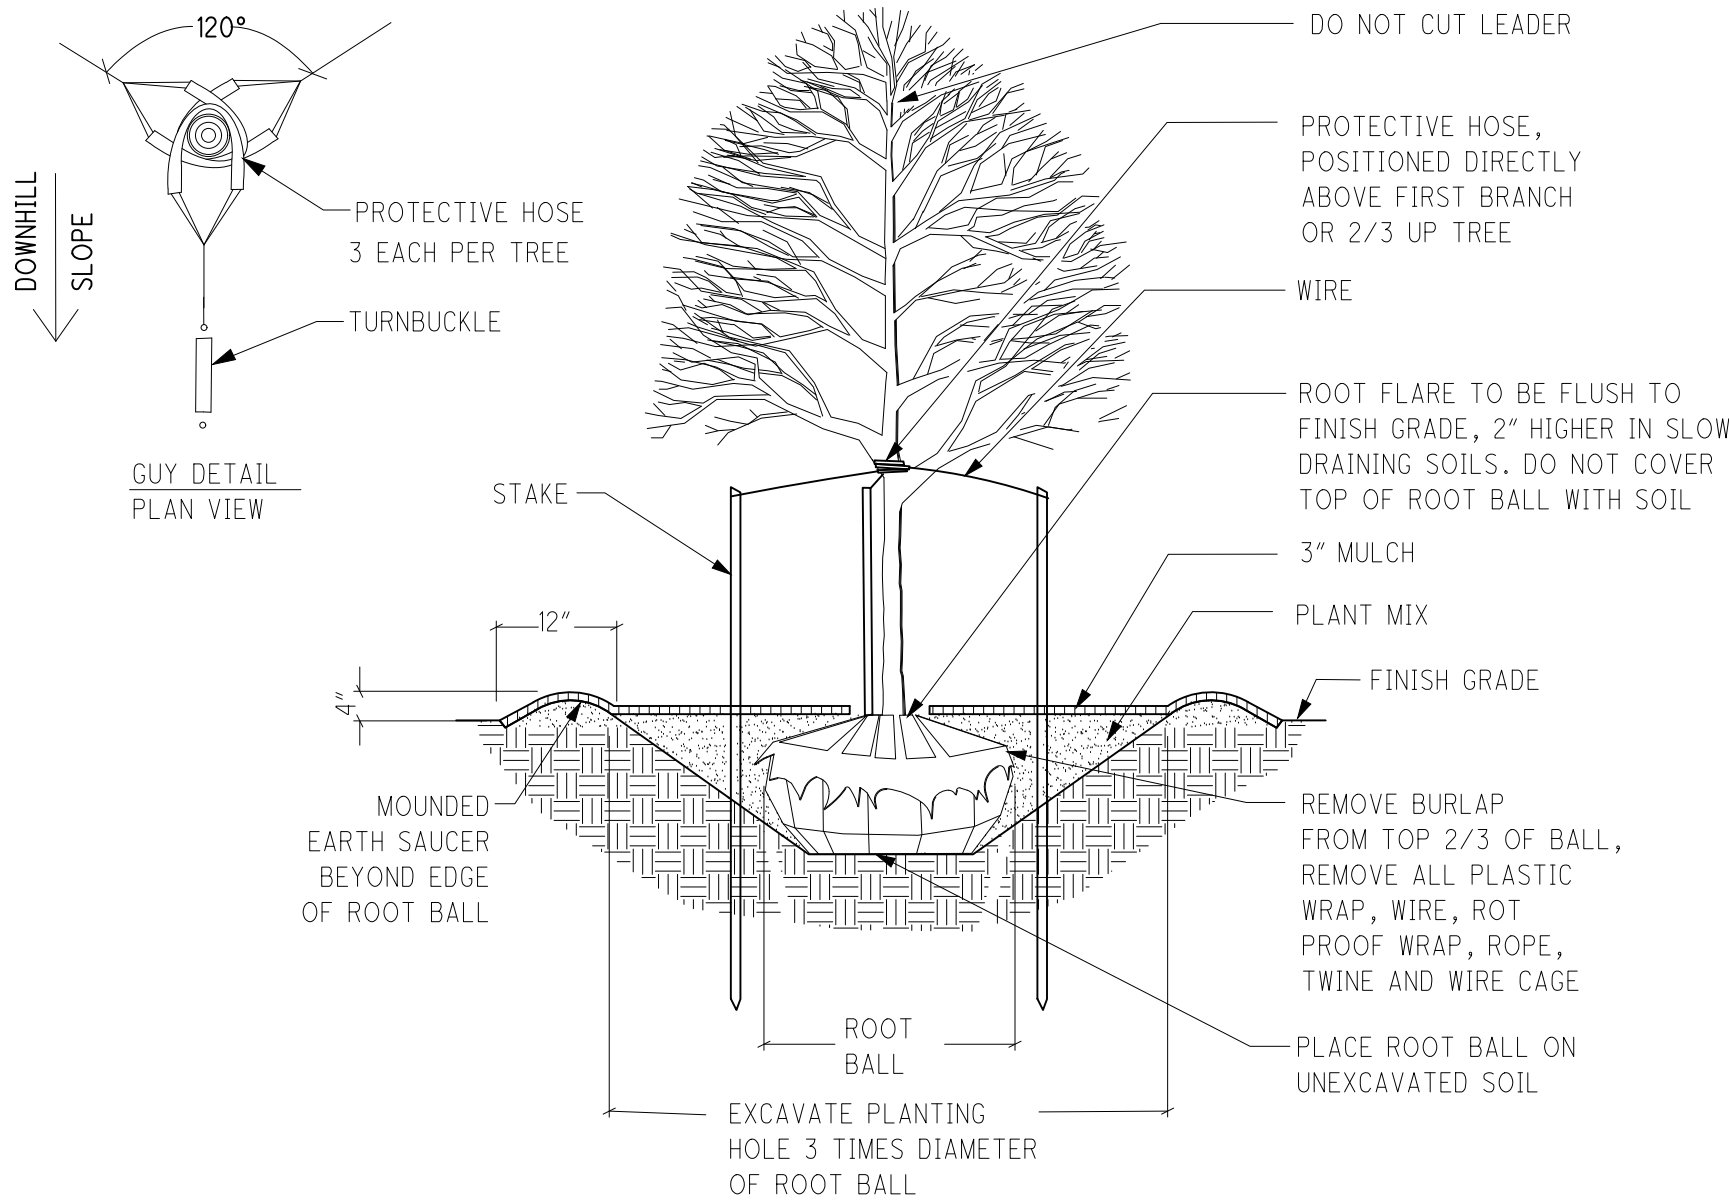

DECIDUOUS TREE PLANTING DETAIL

NO SCALE

ALL SHRUBS PLANTED IN ROWS OR MASSES SHALL BE MATCHED IN SIZE AND SHAPE
SET PLANTS AT PROPER DEPTH, ROOT FLARE SHALL BE AT FINISH GRADE

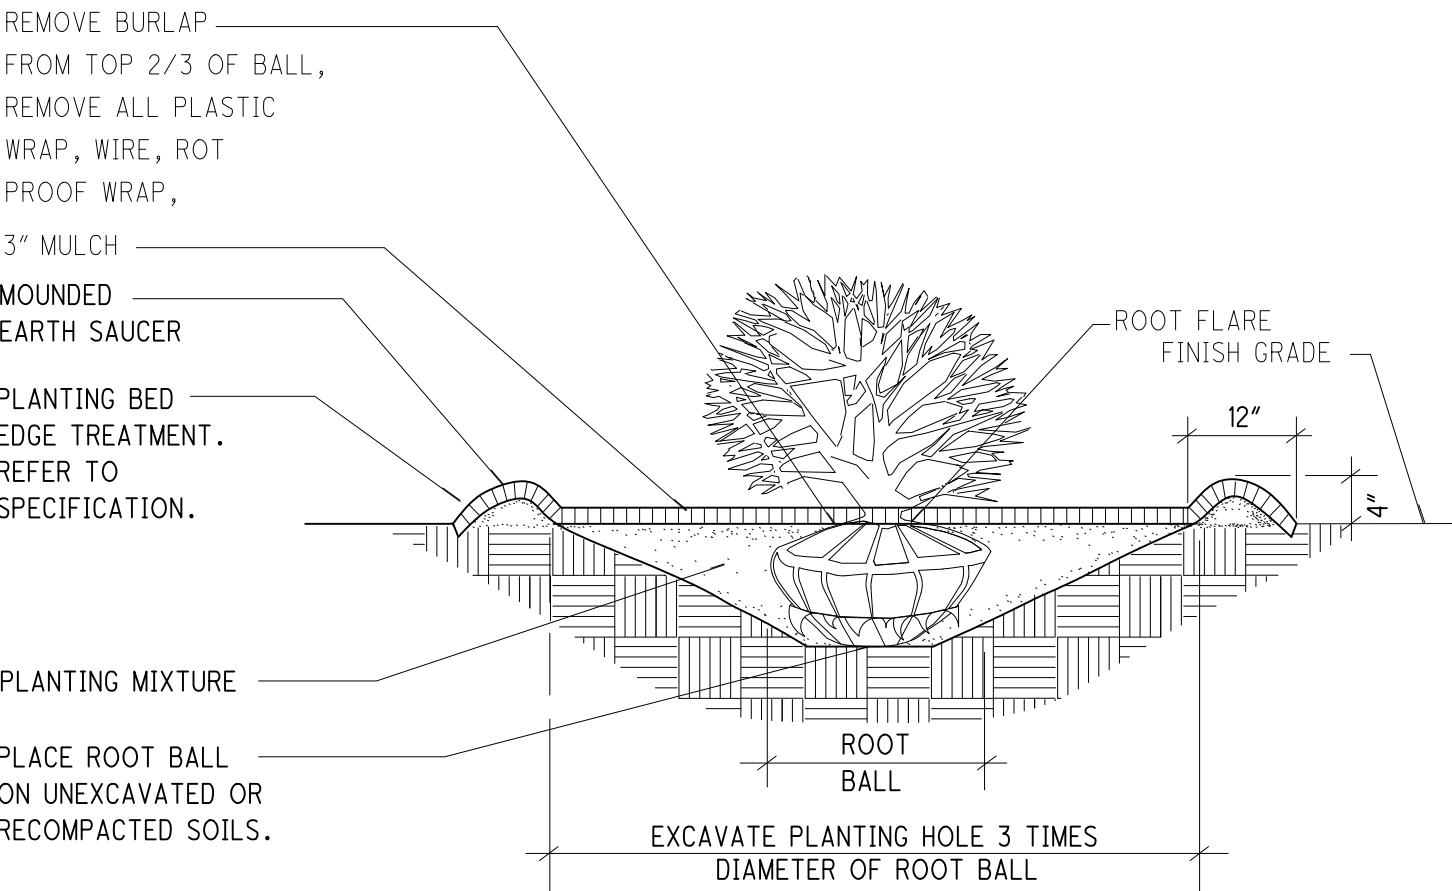


SHRUB PLANTING DETAIL

NO SCALE



NO.	DATE	BY	DESCRIPTION	PROJECT NO.	PROJECT DATE	DRAWN BY	CHECKED BY	PROJECT NO.	PROJECT DATE	DRAWN BY	CHECKED BY	PROJECT NO.	PROJECT DATE	DRAWN BY	CHECKED BY	PROJECT NO.	PROJECT DATE	DRAWN BY	CHECKED BY
1	10/30/2025	JEC	ISSUED FOR PERMITS	1800 INDIAN WOOD CIRCLE	06/11/2025	JEC	JEC	1800 INDIAN WOOD CIRCLE	06/11/2025	JEC	JEC	1800 INDIAN WOOD CIRCLE	06/11/2025	JEC	JEC	1800 INDIAN WOOD CIRCLE	06/11/2025	JEC	JEC
2	12/24/2025	JEC	MONCLOVA TOWNSHIP SUBMITTAL	1800 INDIAN WOOD CIRCLE	06/11/2025	JEC	JEC	1800 INDIAN WOOD CIRCLE	06/11/2025	JEC	JEC	1800 INDIAN WOOD CIRCLE	06/11/2025	JEC	JEC	1800 INDIAN WOOD CIRCLE	06/11/2025	JEC	JEC
				1800 INDIAN WOOD CIRCLE MONCLOVA, OH 43047 TEL: 419.881.1995 FAX: 419.881.1995				PROJECT NO.: 250745 PROJECT NO.: JEC DRAWN BY: JEC CHECKED BY: MJM											
				TECHNICAL SKILL - CREATIVE SPIRIT.															
				Mannik Smith Group www.MannikSmithGroup.com															
				PREPARED FOR: REDEMPTION CHURCH 202 WEST MAIN STREET MASON, OH 45040															
				REDEMPTION CHURCH SPECIAL FUNCTION ACCESSORY BUILDING 8605 SALISBURY ROAD MONCLOVA, OH 43042															
				LANDSCAPE NOTES AND DETAILS															
				L110															

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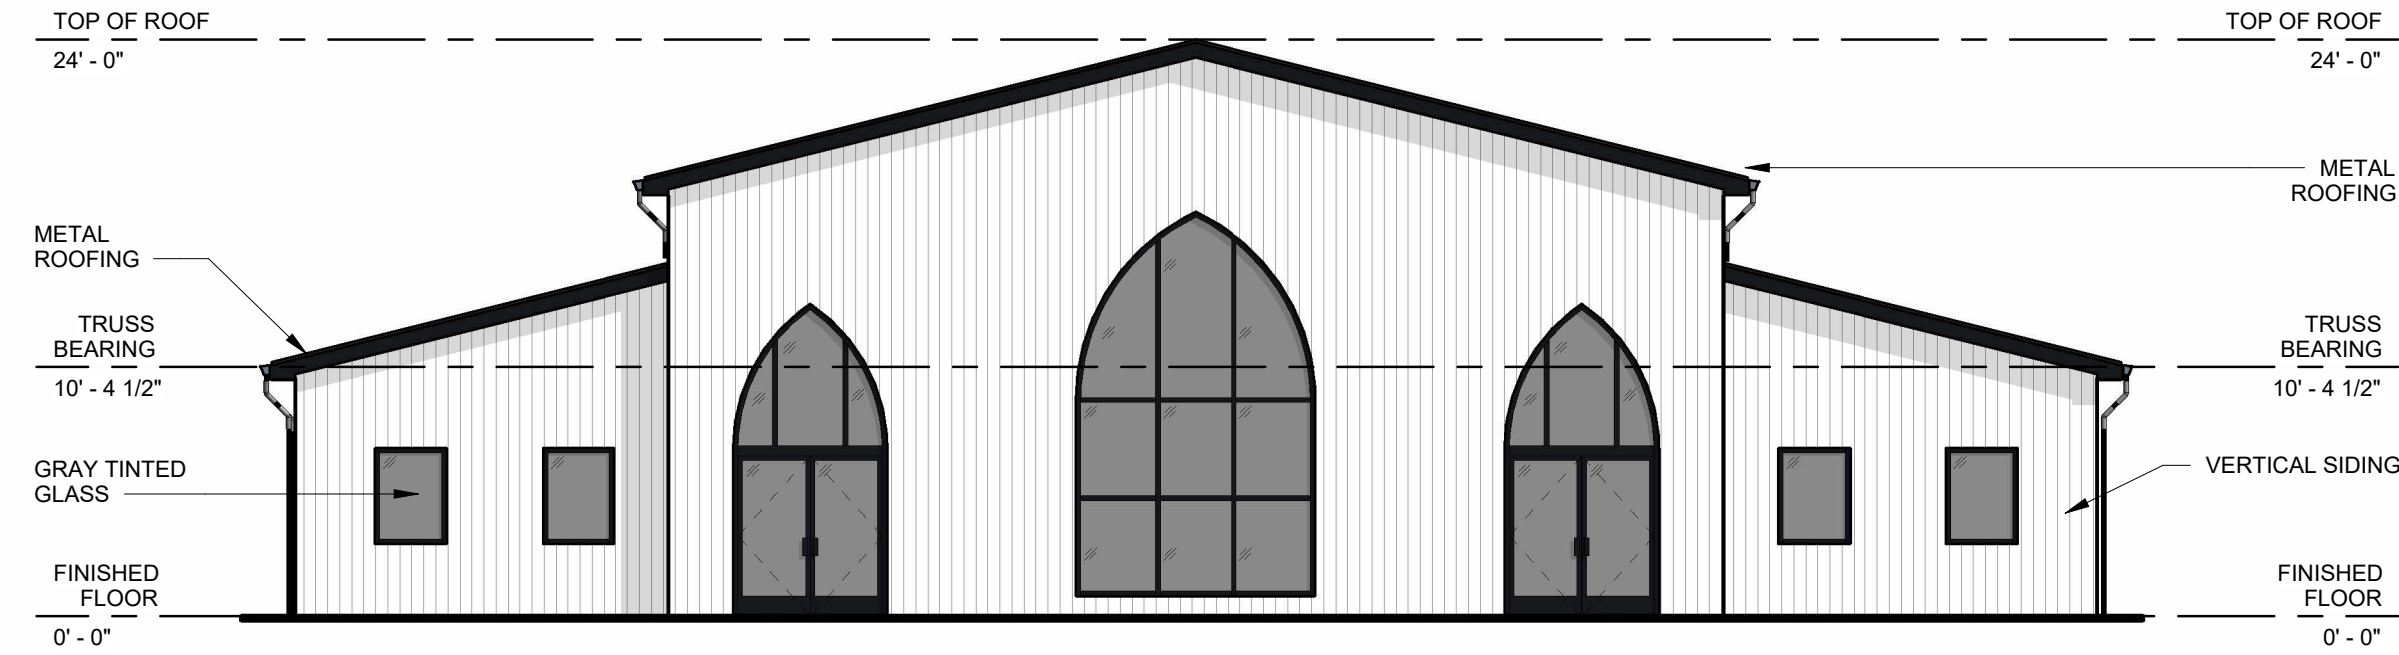
FIRST FLOOR PLAN

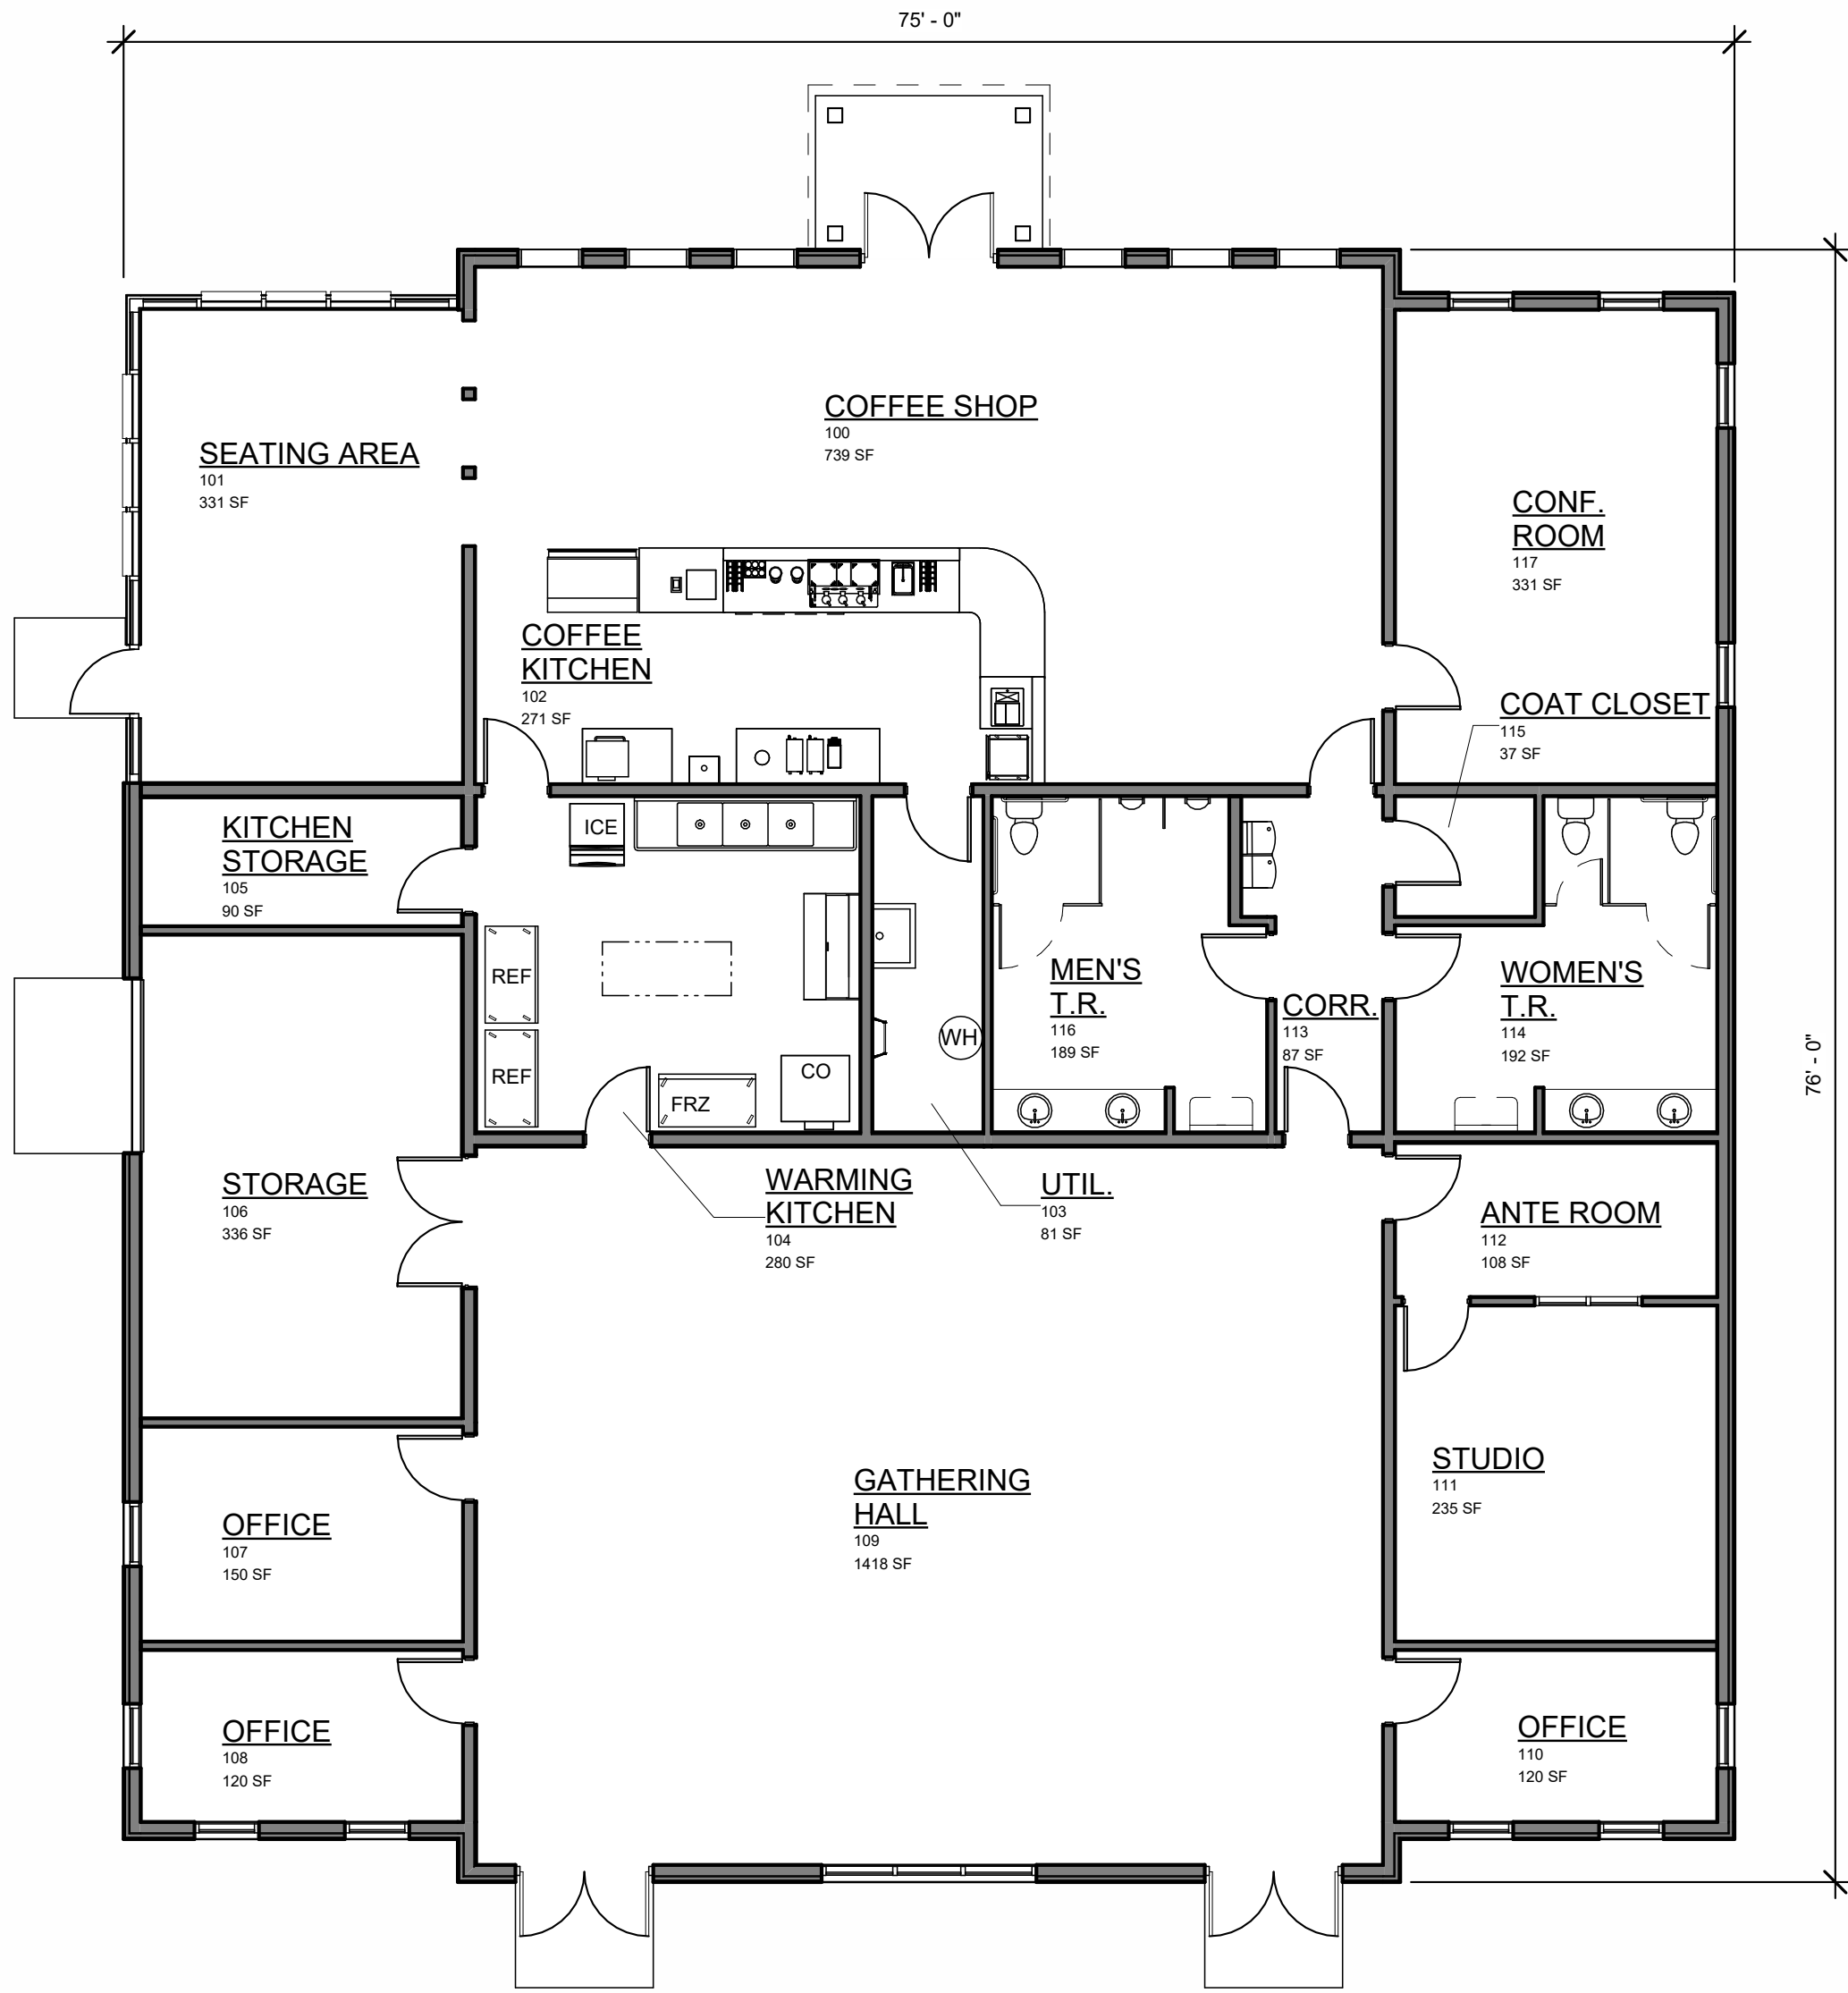1/8" = 1'-0"




NORTH ELEVATION

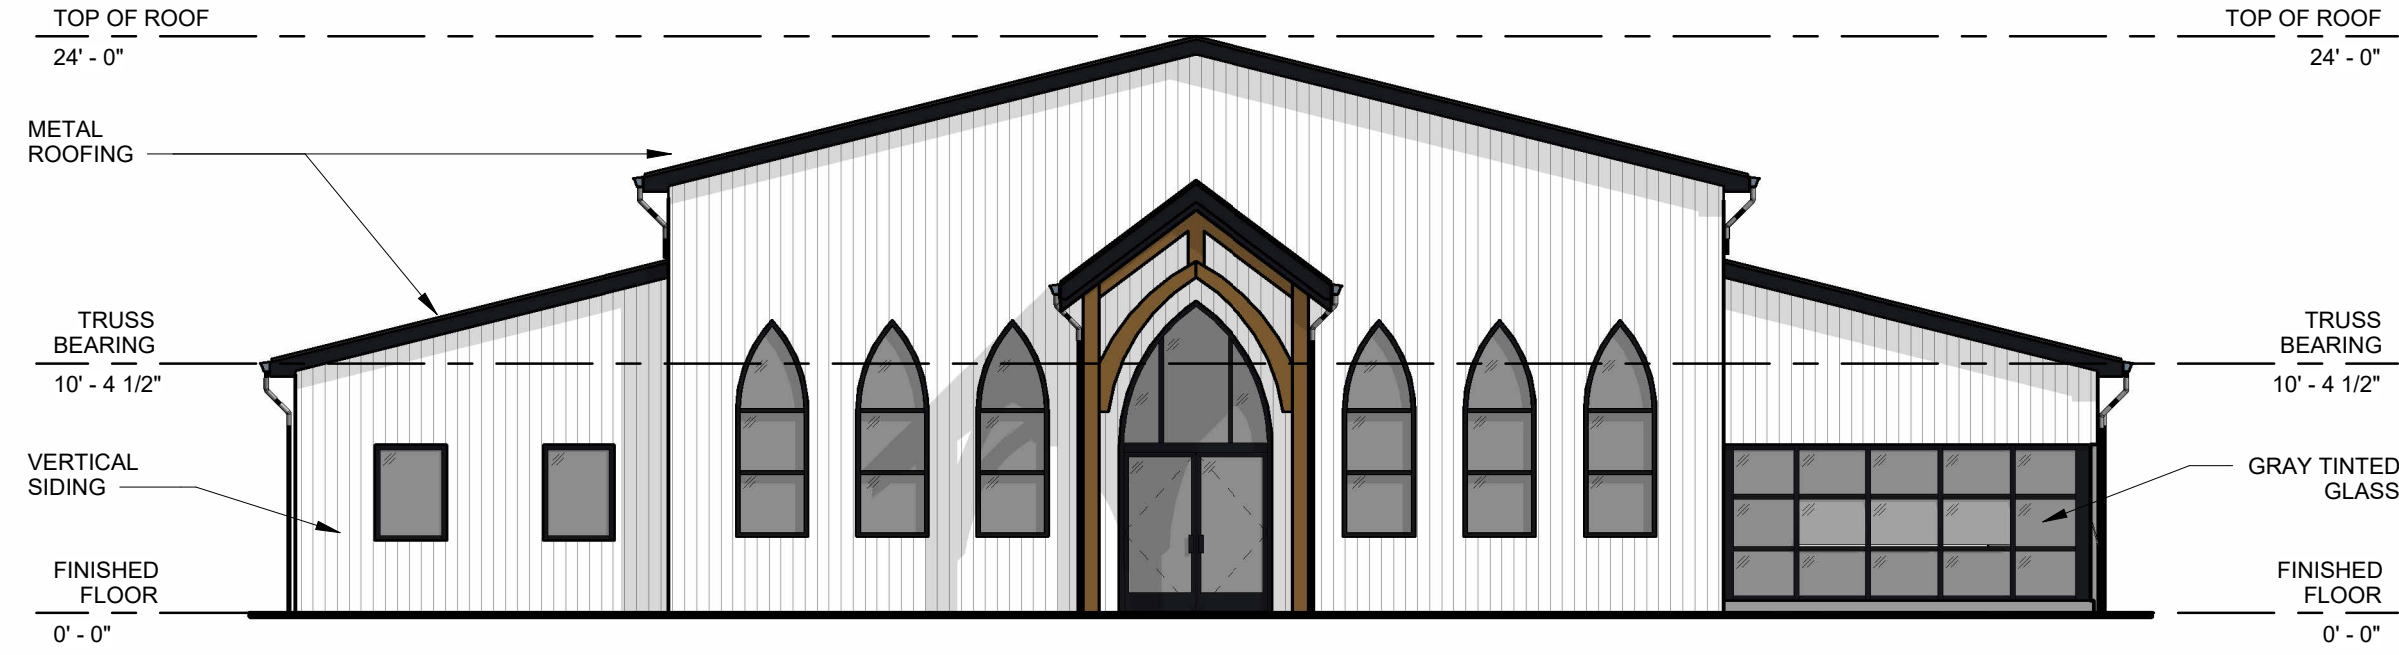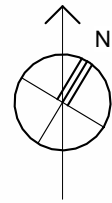1/8" = 1'-0"



SOUTH ELEVATION

1/8" = 1'-0"

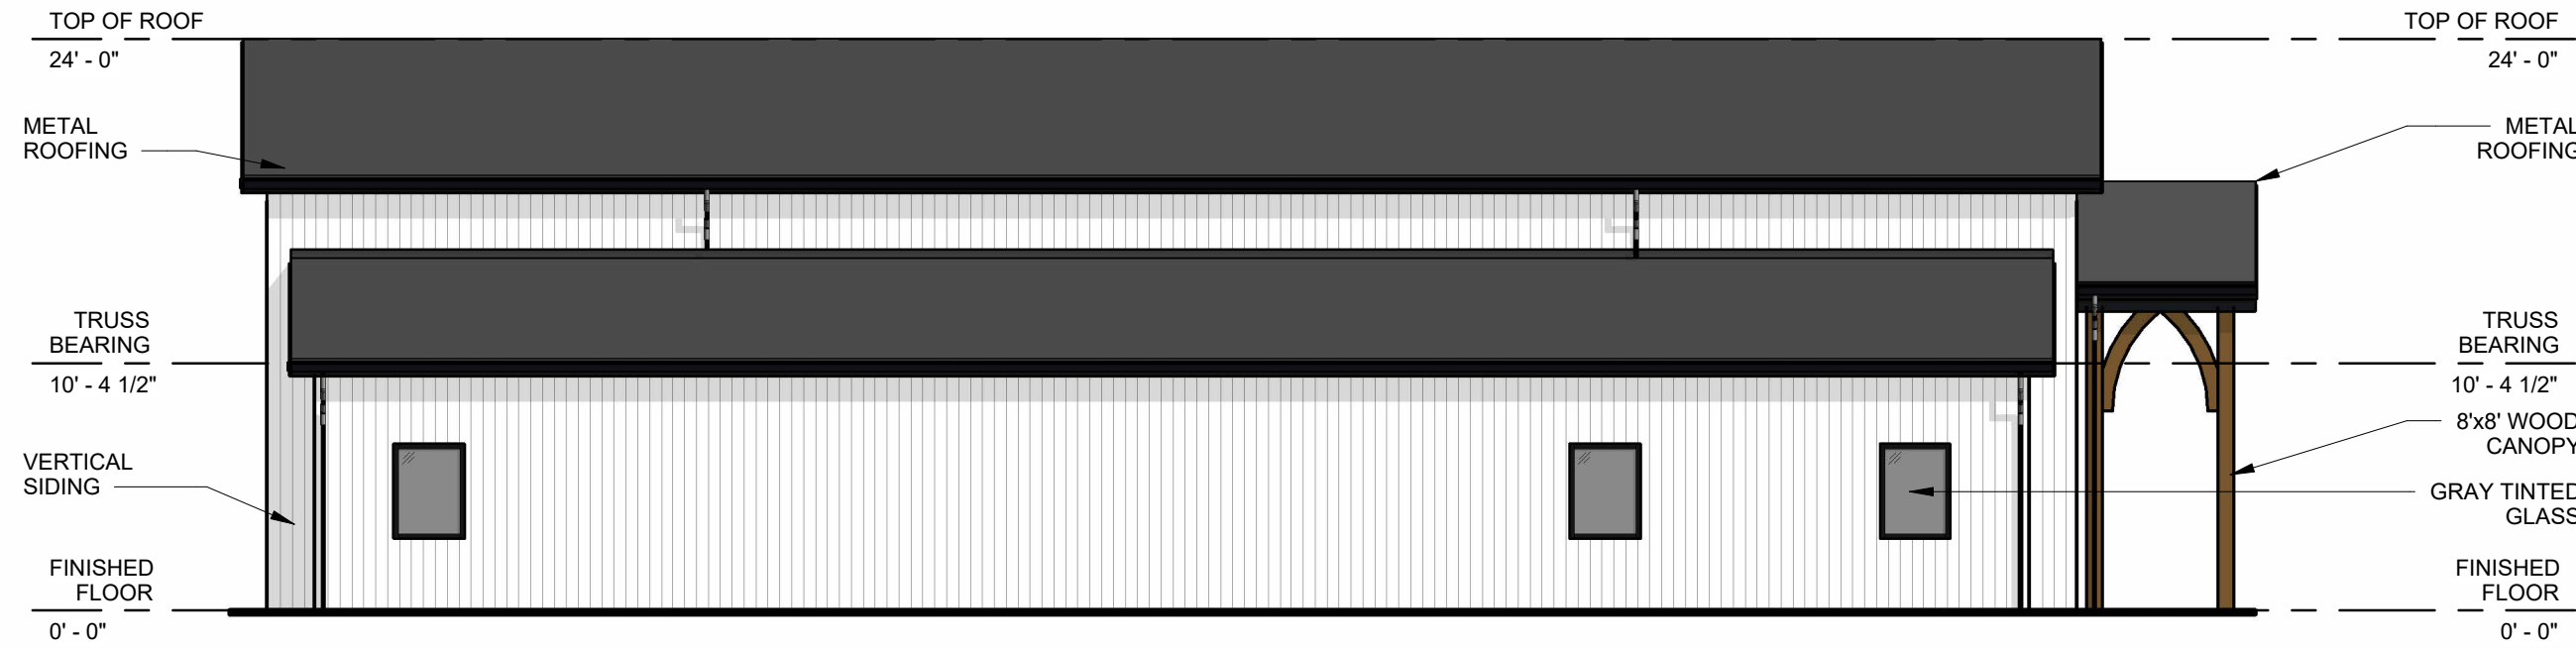

EAST ELEVATION

1/8" = 1'-0"



WEST ELEVATION

1/8" = 1'-0"

GRAPHIC PLAN & ELEVATIONS

PRELIMINARY DESIGN
FELLOWSHIP HALL
8605 SALISBURY ROAD
MONCLOVA, OH 43542

PROJECT NO.
25145

DATE
07/28/2025

DRAWN BY:
J.R.E.

CHECKED BY:
D.W.G.

DATE REVISION:
DRAWINGS

SK-1


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Design: N. Gallant #AEC 2507138
Expirant Date: 12/31/2025




NORTH ELEVATION

1/16" = 1'-0"

MATERIAL SELECTION

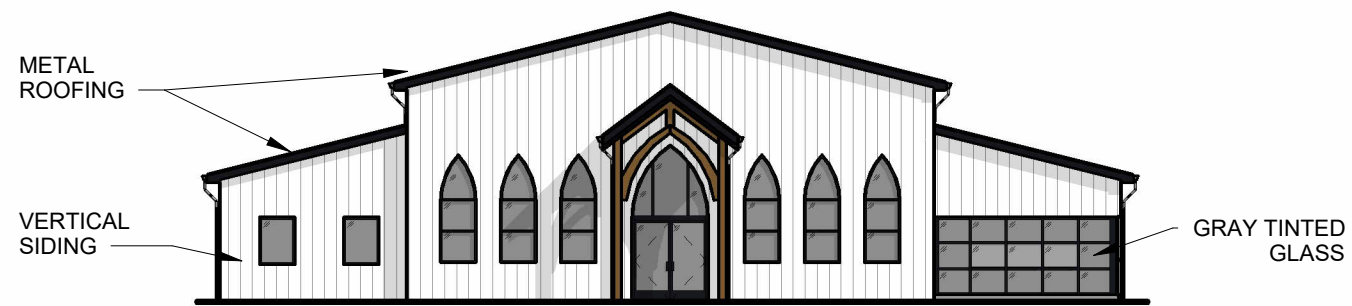PURPOSE	MANUFACTURER	COLOR
METAL ROOFING	PREMIER METALS	BLACK
VERTICAL VINYL SIDING	PROVIA	WHITE (0.050")
DOOR/WINDOW TRIM	MARVIN	EBONY (BLACK)

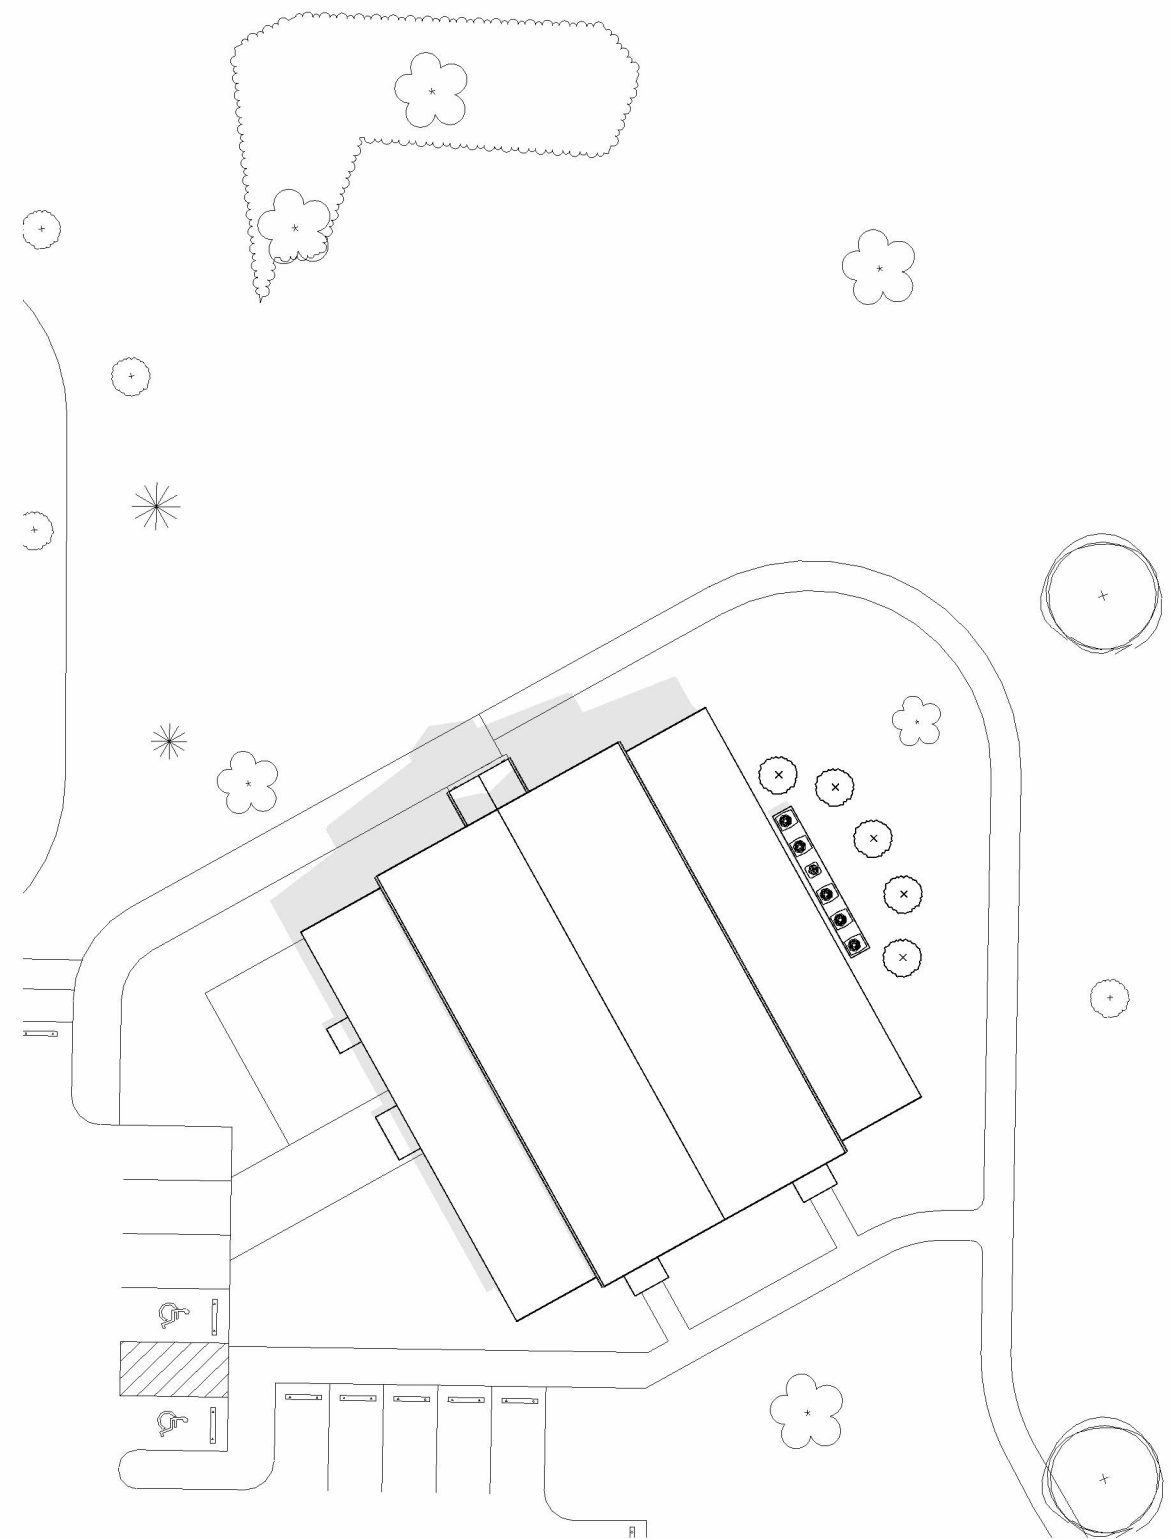

SITE PLAN

1/32" = 1'-0"

